### THE UNITED REPUBLIC OF TANZANIA



### PRESIDENT'S OFFICE REGIONAL ADMINISTRATION AND LOCAL GOVERNMENT

### PROPOSED STANDARD DRAWINGS FOR SCHOOL FACILITIES.


Schedule of Materials, Labour & Drawings for Pre Primary Two Classrooms Block – Hipped (Earthquake zone)

### PROJECT AREA

### TANZANIA MAINLAND

Ministry of Education, Science and Technology,

Government City - Mtumba, AFYA -Street, P. O. Box 10, **40479 DODOMA.**  President's Office, Regional Administration, & Local Government Government City - Mtumba TAMISEMI Street, P. O. Box 1923, 41185 DODOMA.

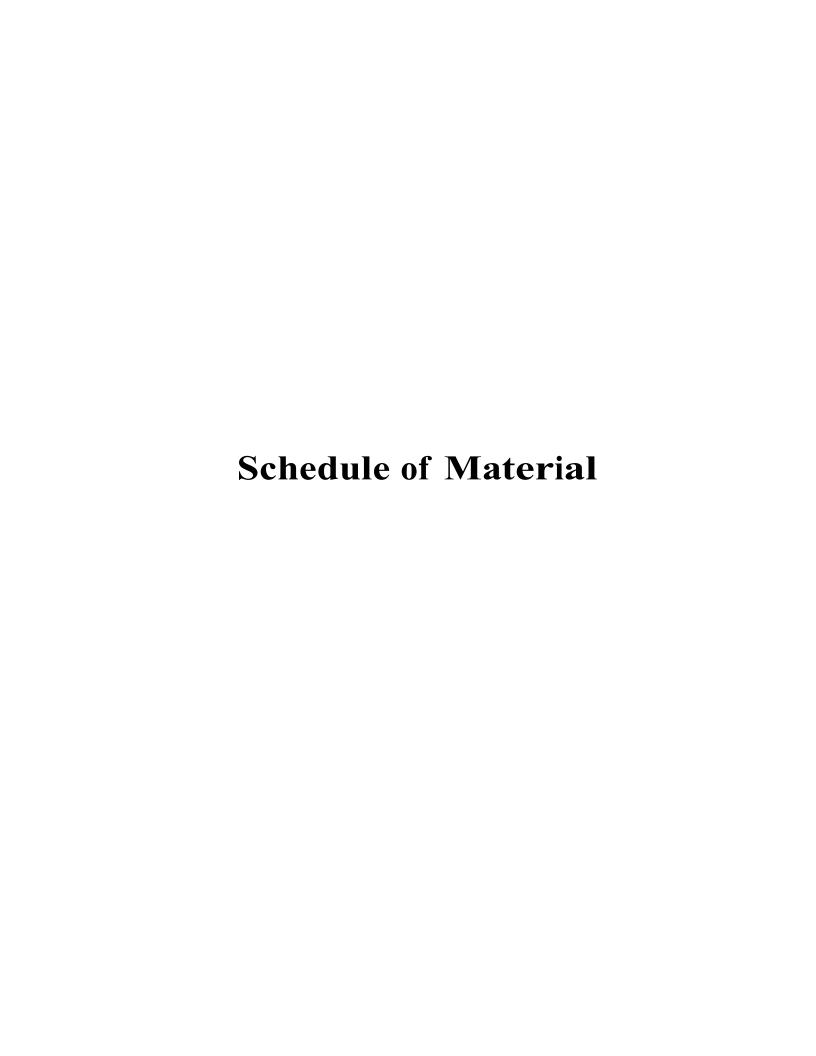

ITEM	DESCRIPTION	QTY	UNIT	PRICE-TZS	AMOUNT
	MATERIALS				
Α	SUB-STRUCTURE -PROVISIONAL				
1	Strip Foundation - Grade 15 Plain				
	Aggregate (3/4")	11	$M^3$		
	Sand	6	$M^3$		
	Cement-50kgs (42.5)	51	Bags		
2	Foundation Walls				
	6" Cement & Sand block - Minimum Strength 3. 5 MPa	1,050	No		
	Sand	6	$M^3$		
	Cement -50kgs (42.5)	23	Bags		
3	Moram, Hardcore & Site sterilization				
	Moram (4.5m <sup>3</sup> lorry)	8	Trips		
	Hardcore 200mm thick - (4.5m <sup>3</sup> lorry)	8	Trips		
	Sand	6	$M^3$		
	Aldrin solution or other and equal approved (1000mls)	2	Bottle		
	Oversite Concrete 100mm thick - 15 grade ,Ground Beam and				
4	base column - 25 grade				
	DPM	160	$M^2$		
	Cement -50kgs (42.5)		Bags		
	Aggregates (1/2")	20	$M^3$		
	Sand	11	$M^3$		
	Reinforcement - 12mm diameter high tensile 460N/mm2	39	PC'S		
	Reinforcement - 8mm diameter high tensile 460N/mm2	35	PC'S		
	Binding Wire - 25kg	10	Kgs		
	A252 Mesh 200 x 200x 6.16kg/m2	4	PC'S		
	Timber 1" X 10 " (5.2m long)	21	PC'S		
	Timber 2" X 2"	12	PC'S		
	Nails-4"	10	Kgs		
	Nails-3"	10	Kgs		
	Supporting props	12	PC'S		
	SUB-TOTAL SUBSTRUCTURE				
B.	SUPERSTRUCTURE				
1	Walls Ring beam & Columns				
	6" Cement & Sand block - Minimum Strength 3. 5 MPa - 230mm	2,065	No		
	6" Cement & Sand block - Minimum Strength 3. 5 MPa - 150mm	235	No		
	DPC 25m	1	Roll		
	Sand	15	$M^3$		
	Cement-50kgs (42.5)		Bags		
	Aggregates (1/2")		$M^3$		
	Reinforcement - 12mm diameter high tensile 460N/mm2	26	PC'S		
	Reinforcement - 8mm diameter high tensile 460N/mm2	25	PC'S		

ITEM	DESCRIPTION	-	UNIT	PRICE-TZS	AMOUNT
	Binding Wire - 25kg	12	Kg		
	Timber 1" X 10" to Sides (5.2m long)	32	PC'S		
	Timber 1" X 5" (Plates)	4	PC'S		
	Timber 2" X 2"	20	PC'S		
	Supporting Props	15	PC'S		
	SUB-TOTAL SUPER STRUCTURE				
C.	ROOF STRUCTURE & COVERING				
1	Roof Structure - Provisional				
'	Timber 2 " X 3" Purlins	66	PC'S		
	Timber 2" X 4" King Post, wall plate and struts		PC'S		
	Timber 2" X 6" Rafter and Tie beam		PC'S		
	Fascia board 1" X 10" -ref. Semi Hardwood (5.2m long)		PC'S		
	Nails -5"		Kgs		
	Nails -4"	40	Kgs		
	Nails -3"	30	Kgs		
	16mm diameter bolt	36	Pc's		
	NOTE: The above softwood timber structure should be pressure impregnated treated				
2	Roof Covering				
	28G IT5 resin coated sheet	262	$M^2$		
	Hips/Ridge and valley - 28 G IT resin coated	13	PC'S		
	Roofing Nails	25	Packet		
3	Gutter's				
	Upvc 100mm half round (6m long)-5"	10	PC'S		
	Upvc 75mm diameter down pipe; Class B		PC'S		
	PVC outlet		PC'S		
	Gutter support bracket		PC'S		
	PVC bend 90'		PC'S		
	PVC bend 45'		PC'S		
	Gutter Clamp 3"		PC'S		
	Connector/reducer		PC'S		
	Connector outer	4	PC'S		
	Corner Inner	4	PC'S		
	Water storage tank; 5000 litres capacity with dust and insect proof lid; 20mm 3Nr tank connectors; 25mm 1Nr wash - out tank connector; 20mm high pressure ball float operated stop valve; all connections to IPS	1	PC'S		
	SUB-TOTAL ROOF STRUCTURE & COVERING				
D.	CEILING				
	Gypsum board -9mm thick	58	PC'S		
	Plain Cornice (8ft)	40	PC'S		
	Screw 1.25" 500pcs/box	3	Box		
	Gypsum powder	10	Bags		
	Fiber tape (90m)		Roller		
	Treated softwood Timber 2" X 2"		PC'S		
	Nails 4"		Kgs		
	Nails 3"				
	SUB-TOTAL FOR CEILING	∠5	Kgs		

ITEM	DESCRIPTION	QTY	UNIT	PRICE-TZS	AMOUNT
E.	DOOR				
1	40mm thick hardwood Matchboarded door shutter				
	820 x 2100mm high	2	PC'S		
2	45 x 145mm Frames (hardwood),Varnish				
	900 x 2500 mm high frame	2	PC'S		
	5mm thick clear glass to Vents	1	m2		
	16mm diametere burglar bars -1100mm long	6	Pcs		
	Brush 3"	3	Pcs		
	Sand paper (msasa) No.80	3	LM		
	Clear Varnish - 4Litres	1	TIN		
	Thinner for Varnish	3	Litres		
3	Ironmongeries - ref Union				
	Mortice lock Three lever	2	No		
	Brass hinges - 100mm	3	Pairs	_	
	SUB-TOTAL FOR DOORS				
F.	<u>WINDOWS</u>				
	Aluminium sliding Window comprising 100mm x 1.2mm thick				
	standard aluminium profile ex-china/Turkey infill with 5mm thick glass complete with mosquito proofing panel, including				
	all accessories, ironmongeries, cutting and pinning lugs				
	1500 X 2000mm high	10	PC'S		
	SUB-TOTAL FOR WINDOWS				
G.	FINISHING				
1	Floor finishing				
	Bedding/Backing; cement sand and Chipping (1:2:2); to steel				
	finishing				
	40mm Thick granolithic floor screed steel trowlelling to smooth				
	finishing		$M^3$		
	Sand Cement-50kgs (42.5)		Bags		
	Chipping "1/4"		M <sup>3</sup>		
	2mm thick plastic Strips	205			
2	Wall Finishing -15mm thick (1:4)	200	IVI		
	Sand	11	$M^3$		
	Cement-50kgs		Bags		
	Sand paper (msasa) No.120		M		
	White cement - 40kg		Bags		
	Gypsum powder		Bags		
	SUB-TOTAL FOR FINISHING	10	Dags		
Н.	BALUSTERS & HANDRAIL			-	
	Supply and fix steel balustrade overall height 900mm high,				
	comprising 50mm diameter hollow section mild steel pipe top and				
	bottom rail, 38mm diameter intermediate rails, 50mm diameter				
	vertical rails 900mm high spaced at interval of 450mm centres				
	to centres including all bolts, plates and associated accessories				
	and welded works, red oxed and painted as per				
	architectural drawing to the aproval of Project Surpervisor.	18	m		
	SUB-TOTAL BALUSTERS & HANDRAIL	10			

ITEM	DESCRIPTION	QTY	UNIT	PRICE-TZS	AMOUNT
J.	PAINTING & DECORATION				
	Emulsion Paint - 20 LTRS	9	buckets		
	Weather guard Paint - 20 LTRS	3	buckets		
	Washable paint -20 LTRS	3	buckets		
	Primer paint -20 LTRS	2	buckets		
	Solvent - 5LTRS	2	TIN		
	Brush 3"	4	Pcs		
	Roller	4	Pcs		
	Blackboard paint	4	Litres		
	Gloss paint-4LTR	3	TIN		
	Bitumen paint - 4Litres	4	TIN		
	SUB-TOTAL FOR PAINTING&DECORATION				
K.	ELECTRICAL INSTALLATION				
	Single fluorescent fitting Complete,LED philips or other equal approved	18	No		
	Double switch socket ABB or other equal approved	2	No		
	Main switch 6way,1PH with integral RCD 100A/300mmA ABB other equal approved	1	No		
	<b>NB:</b> Cables for 1.5sqmm 2.5sqmm and 4sqmm should be EURO or other equal approved				
	Single core wire 1.5sqmm - Red	2	Roll		
	Single core wire 1.5sqmm - Black	2	Roll		
	Single core wire 1.5sqmm -green	2	Roll		
	Single core wire 2.5sqmm - red	50			
	Single core wire 2.5sqmm	50	M		
	Single core wire 2.5sqmm green	50	M		
	Ceiling fan National or other equal approved		PC's		
	3gang 1 way switch ABB or other equal approved		No		
	1gang 1 way switch ABB or other equal approved		No		
	2gang 1 way switch ABB or other equal approved Earth rod approved copper 16mm not less than 1200mm	1			
	Earth wire 4sqmm	20	No M		
	Metal box twin		No		
	Metal box single		No		
	Junction box		No		
			PC's		
	Conduit pipe				
	Elbow Conduit coupling		PC's		
			PC's		
	Round cover		PC's		
	Round box		PC's		
	Fine screw	2	PACKET		
	plastic clips 22mm		BOX		
	Bulk head light fitting	4	PCS		
	SUB-TOTAL FOR ELECTRICAL INSTALLATIONINSTALLATION				

ITEM					AMOUNT -TZS
	SUMMARY				
	2NA CLASSDOOM DLOCK FOR RDE DRIMARY FARTHOLIAKE 7	ONE			
	2No CLASSROOM BLOCK FOR PRE PRIMARY - EARTHQUAKE Z	ONE			
A.	SUB-STRUCTURE -PROVISIONAL				
7	OOD-OTTOOTONE -I NOVIGIONAL				
B.	SUPERSTRUCTURE				
C.	ROOF STRUCTURE & COVERING				
D.	CEILING				
E.	DOOR				
F.	WINDOWS				
G.	FINISHING				
H.	BALUSTERS & HANDRAILS				
_					
J.	PAINTING & DECORATION				
17					
K.	ELECTRICAL INSTALLATION				
	TOTAL BUILDING MATERIALS CARRIED TO GENERAL SUMMARY	,			
	TO THE BOILDING INVIENDED OF WHITE TO GENERAL COMMINANT				
	ADD:				
	LABOUR COST CARRIED TO GENERAL SUMMARY: (Improve and F	Fill the res	spective	Labour form)	
	Note:				
	i. Refer specification and number of Furniture(s) for Pre primary				
	ii. Refer General Summary for: Preliminary, Transportation and S	Supervision	on Cost	S	
	iii. Preliminary cover the following item:				
	- Setting out working tools, Equipments, Temporary toilets, water				
	- Power for the works, Security, store, Materials test, levelling, h	noldings	and ren	noval of rubbi	sh.
	iv. Supervision cost depend on guideline of the specific project				
	v. Installation of Ceiling Fan is an option, depend on whether con-	dition of	specific	area .	

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### PROPOSED STANDARD DRAWINGS FOR SCHOOL FACILITIES.


Schedule of Materials, Labour & Drawings for Three stances Toilet block for Pre Primary school

### **PROJECT AREA**

### TANZANIA MAINLAND

Ministry of Education, Science and Technology,

Government City - Mtumba, AFYA -Street, P. O. Box 10, **40479 DODOMA.**  President's Office, Regional Administration, & Local Government Government City - Mtumba TAMISEMI Street, P. O. Box 1923, 41185 DODOMA.

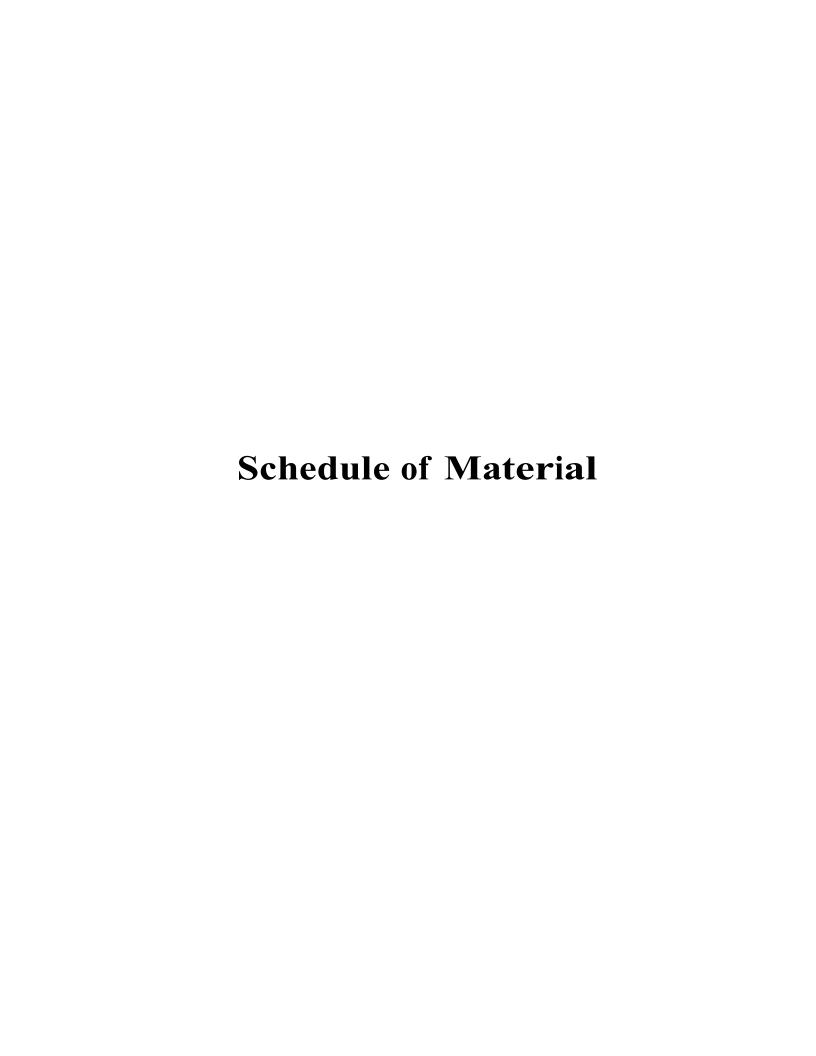

ITEM	DESCRIPTION	QTY	UNIT	PRICE-TZS	AMOUNT
	<u>MATERIALS</u>				
Α	SUB-STRUCTURE -PROVISIONAL				
1	Strip Foundation - Grade 15 Plain				
	Aggregate (3/4")		$M^3$		
	Sand		$M_3$		
	Cement-50kgs (42.5)	14	Bags		
2	Foundation Walls				
	6" Cement & Sand block - Minimum Strength 3. 5 MPa				
	Sand	2	$M^3$		
	Cement -50kgs (42.5)	5	Bags		
3	Moram, Hardcore & Site sterilization				
	Moram (4.5m³ lorry)	1	Trips		
	Hardcore (4.5m³ lorry)	1	Trips		
	Sand	2	$M^3$		
	Aldrin solution or equal 1000mls	1	Bottle		
	Ground Beam - 20 grade, columns and Ramp  DPM	1.5	$M^2$		
			M <sup>2</sup> Bags		
	Cement -50kgs (42.5) Aggregates (1/2")		M <sup>3</sup>		
	Sand		$M^3$		
	Reinforcement - 12mm diameter high tensile		PC'S		
	Reinforcement - 8mm diameter		PC'S		
	Binding Wire		Kg		
	A252 Mesh 200 x200x6.16kg/m2		PC'S		
	Timber 1" X 10" (3.6m long)		PC'S		
	Timber 2" X 2"		PC'S		
	Nails-4"		Kgs		
	Nails-3"		Kgs		
	Supporting props		PC'S		
	SUB-TOTAL SUBSTRUCTURE				

EM	DESCRIPTION	QTY	UNIT	PRICE-TZS	AMOUNT
В.	SUPERSTRUCTURE				
1	Walls & Ring beam & Columns				
	6" Cement & Sand block - Minimum Strength 3.5 N				
	Cement & Sand Perforated blocks	0	No		
	DPC 25m long x 1m wide)	5	M		
	Sand	4	$M^3$		
	Cement-50kgs (42.5)	15	Bags		
	Aggregates (1/2")	1	$M^3$		
	Reinforcement - 12mm diameter high tensile	6	PC'S		
	Reinforcement - 8mm diameter	4	PC'S		
	Binding Wire	2	kg		
	A252 Mesh 200 x200x6.16kg	0	PC'S		
	Timber 1" X 10" to Sides (3.6m long)	3	PC'S		
	Timber 1" X 6" (Plates)		PC'S		
	Timber 2" X 2"		PC'S		
	Supporting Props		PC'S		
	Selection of the select				
	SUB-TOTAL SUPER STRUCTURE				
<b>.</b>	ROOF STRUCTURE & COVERING				
1					
ı	Roof Structure - Provisional (3.6m long) Timber 2 " X 3" Purlins	1	PC'S		
	Timber 2" X 4" Wall plate,Rafter		PC'S		
	Fascia board 1" X 8"		PC'S		
	Nails -5"		Kgs		
	Nails -4"		Kgs		
	Nails -3"		Kgs		
	NOTE: The above softwood timber structure should be pressure impregnated treated		Ng3		
2	Roof Covering				
	28G IT5 resincoated sheet 3m long	5	Pcs		
	Roofing Nails		Packet		
	TO COLLECTION			C/F	
	10 COLLECTION			C/1	

ITEM	DESCRIPTION DESCRIPTION	QTY	UNIT	PRICE-TZS	AMOUNT
11 = / V	ROOF STRUCTURE & COVERING CONT	QII	OINII	FRICE-123	AMOUNT
	ROOF STRUCTURE & COVERING CONT			D/E	
3	Gutter's			B/F	
	Upvc 100mm half round (6m long)-5"	1	PC'S		
	Upvc 75mm diameter down pipe; Class B		PC'S		
	PVC outlet		PC'S		
	PVC bend 45'		PC'S		
	Gutter support bracket		PC'S		
	Gutter Clamp 3"		PC'S		
	Connector		PC'S		
	Connector outer		PC'S		
	Corner Inner		PC'S		
	SUB-TOTAL ROOF STRUCTURE & COVERING				
D.	DOOR				
1	40mm thick hardwood (mninga) or equal and				
	aproved paneled door shutter				
	920 x 2100mm high	1	PC'S		
	720 x 2100mm high	2	PC'S		
2	Frames (hardwood), Varnish, Glass & Burglar bar				
	1000 x 2500 mm high frame	1	PC'S		
	800 x 2500 mm high frame	2	PC'S		
	Brush 3"	1	Pcs		
	Sand paper (msasa) No.80	1	LM		
	Clear Varnish - 4Litres	1	TIN		
	Thinner for Varnish -4Litres	1	Litres		
	Door grill with 38mm x 4mm flat bars, 25mm x 25mm square pipespainted with red oxide				
	1000 x 1500mm high	1	No		
	1000 x 750mm high	3			
3	IronMongeries - ref Union				
	Barrel bolt with pad lock	3	No		
	Flush bolt	3	No		
	Brass hinges - 100mm	5	Pairs		
	SUB-TOTAL FOR DOORS				

ITEM	DESCRIPTION	QTY	UNIT	PRICE-TZS	AMOUNT
E.	FINISHING				
1	Floor finishing				
•	Bedding/Backing; cement sand (1:2); to steel				
	finishing				
	Sand	1	$M^3$		
	Cement-50kgs (42.5)	2	Bags		
	300 x 300 x 8mm Non slippery Porcelain floor tiles	F	D		
	(1.35 sqm per Box)	5	Box		
2	Wall Finishing				
	Sand	2	$M^3$		
	Cement-50kgs		Bags		
	250 X 400 x 8mm Wall tiles (1.5 Sqm/Box)	18	Вох		
	Wall Puty		Bags		
	SUB-TOTAL FOR FINISHING		9-		
F.	PAINTING & DECORATION				
1.	Emulsion Paint - 20 LTRS	2	buckets		
	Weather guard Paint - 10 LTRS		buckets		
	Washable paint -10 LTRS		buckets		
	Primer paint -5 LTRS	1	buckets		
	Solvent - 5LTRS	1	TIN		
	Brush 3"	2	Pcs		
	Roller	1	Pcs		
	Gloss paint-4LTR	1	TIN		
	Bitumen paint - 4Litres	1	TIN		
	SUB-TOTAL FOR PAINTING&DECORATION				
G.	PLUMBING & SANITARY INSTALLATION-PROVISIONAL				
	Semi pedestal Hand washing basin complete	No	2		
	WC Asian type complete with p-trap 9 liters single				
	flush cistern Shataf stainless steel 304, 1000mm long braided	No	2		
	hose.	No	2		
	Angle Valve chrome plated brass	No	9		
	HWB PVC-U trap 1.1/4'' Falcon	No	2		
	Looking mirror (600mm by 800mm by 6mm)	No	2		
	PVC-U Floor drainer/Trap 110mm	No	1		
	Strainer albeetony/venus	No	1		
	Ceramic toilet paper holder	No	2		
	Toilet brush holder	No	2		
	Complete set of walfare for person with disability,				
	Western WC, stainless steel 304 grab bar, stainless				
	steel 304 folding hand rail, HWB, Pillar tap, Floor				
	drainer and bib cork	No	1		

M DESCRIPTION OF WORKS	UNIT	QTY	PRICE	AMOUNT
PIPES WORK IN BUILDING				
A: SUPPLY PIPE PN 16				
PPR/IPS pipes class B argentina 3/4"	Pcs	2		
PPR/IPS socket (20Ø) 3/4"	No	3		
PPR/IPS elbow (20Ø) 3/4"	No	15		
PPR/IPS tee (20Ø) 3/4"	No	9		
PPR/IPS niple (20Ø) 3/4"	No	10		
PPR/IPS reducing bush (20Ø) 3/4" to 1/2"(15Ø)	No	9		
PPR/IPS pipes class B argentina 1"(32Ø)	Pcs	2		
PPR/IPS socket 1"(32Ø)	No	6		
PPR/IPS elbow 1"(32Ø)	No	4		
PPR/IPS tee 1"(32Ø)	No	4		
PPR/IPS niple 1"(32Ø)	No	10		
PPR/IPS reducing bush (32Ø) 1" to 3/4"(20Ø)	No	6		
PPR/IPS pipes class B argentina 11/2"(50Ø)	Pcs	2		
PPR/IPS socket 11/2"(50Ø)	No	6		
PPR/IPS elbow 11/2"(50Ø)	No	4		
PPR/IPS tee 11/2"(50Ø)	No	4		
PPR/IPS niple 11/2"(50Ø)	No	4		
PPR/IPS reducing bush (50Ø) 11/2" to 1"(32Ø)	No	9		
B: SOIL DRAINAGE PVC-U PN6 PIPES AND FITINGS -				
PVC-U pipe class B 1.1/4"	Pcs	2		
PVC-U elbow 1.1/4", 135deg	No	3		
PVC-U elbow 1.1/4", 90 deg	No	4		
PVC-U Ytee 1.1/4"	No	2		
PVC-U pipe class B 4"	Pcs	2		
PVC-U elbow 4"	No	6		
PVC-U Ytee 4"	No	2		
PVC-U WYES 4"	No	1		
PVC-U Tangit 1000g	No	2		
P-Trap ERA 4"	No	1		
PE 100 Gully trap 4",ERA	No	1		
, , , ,	-			

	DESCRIPTION		HAUT		A AAOUNT
ITEM		QTY	UNIT	PRICE-TZS	AMOUNT
	EXTERNAL WORK A: Drainage works				
	PVC-U pipe class B plascon 4" 6m	Pcs	6		
	ManHole cover 600mm x 600mm medium	No	4		
	Gully trap cover 300mm x 300mm medium	No	3		
	B: Water Supply Pipe HDPE, PE100	140	0		
	1.5" HDPE supply pipes Class C	m	12		
	HDPE bend 1.5"	No	2		
	HDPE Tee Polly to polly 1.5"	No	3		
	HDPE polly coupling 1.5"	No	4		
	1.25" HDPE supply pipes Class C	m	12		
	HDPE bend 1.25"	No	5		
	HDPE Male connector 1.25"	No	4		
	HDPE Tee Polly to polly 1.25"	No	4		
	HDPE polly coupling 1.25"	No	4		
	VALVES AND CONTROLS				
	Bib cork pex/martex 1/2" PN 16	No	2		
	Gate valve pex/martex 3/4" PN 16	No	3		
	Ball valve 11/4"	No	1		
	WATER STORAGE TANK				
	2,000litres water storage tank	No	1		
	1,000litres water storage tank	No	1		
	Tank connector 1"	No	2		
	Clamp 3"	PC'S	1	_	
	SUB-TOTAL FOR PLUMBING & SANITARY INSTALLATION-				
•	RISER FOR WATER TANK (4M HIGH)				
	6" Cement & Sand block - Minimum Strength 3.5 MPa	190	No		
	Cement-50kgs	8	Bags		
	Aggregates (1/2")	1	МЗ		
	Sand	3	МЗ		
	Reinforcement - 12mm diameter high tensile	4	Pcs		
	Binding Wire - 25kg	1	kg		
	Timber 1" X 10" to Sides (3.6m long)	6	Pcs		
	Nails-4"	1	kg		
	Nails-3"	1	kg		
	TOTAL; RISER FOR TANK				

ITEM	DESCRIPTION	QTY	UNIT	PRICE-TZS	AMOUNT
J.	MANHOLE, GULLY TRAP, SEPTIC TANK, SOAK PIT.				
	MANHOLE:				
	Construct standard manhole size 600 x 600mm average depth 850mm deep;	No	3		
	GULLY TRAP				
	Construct a standard gully trap 300×300mm deep	No	3		
	SEPTIC TANK:				
	Construct septic tank overall internal dimensions; size 3300 x 2400x 3000mm.	No	1		
	SOAK PIT (S.P)				
	Construct Soak pit overall size 3000mm diameter x 3500mm high	No	1		
	TOTAL; MANHOLE, GULLY TRAP, SEPTIC TANK, SOAK PIT.				

ELECTRICAL INSTALLATION			
PRE PRIMARY TOILET			
Single fluorescent fitting Complete,LED philips or	4	No	
NB: Cables for 1.5sqmm 2.5sqmm and 4sqmm should be EURO or other equal approved			
Single core wire 1.5sqmm - Red	30	М	
Single core wire 1.5sqmm - Black	30	M	
Single core wire 1.5sqmm -green	30	M	
Twin cable wire 2.5sqmm	30	M	
1gang 1 way switch ABB or other equal approved	3	No	
Ceiling light complete with energy saver 11w	3	No	
Metal box single	3	No	
Junction box	3	No	
Conduit pipe	3	PC's	
Elbow	3	PC's	
Conduit coupling	3	PC's	
Round cover	3	PC's	
Round box	1	PC's	
plastic clips 22mm	1	вох	
SUB-TOTAL FOR ELECTRICAL INSTALLATIONS			

SCHEDI	JLES OF MATERIALS PRE PRIMARY STAN	ICES		THREE STANCE	S TOILET WET ARE
ITEM	DESCRIPTION	QTY	UNIT	PRICE-TZS	AMOUNT
L	Steel handrails to ramp				
	Supply and fix steel support handrails 750mm high				
	comprising 38mm diameter hollow section pipe				
	top, bottom and vertical rails spaced at 300mm				
	centres to centres as per Architectural drawings	8	m		
	SUB-TOTAL FOR HANDRAILS				

	GENERAL SUMMARY	AMOUNT TZS
	2no stances with One Disability stances toilets block -Wet area	
Α.	SUB-STRUCTURE -PROVISIONAL	
В.	SUPERSTRUCTURE	
C.	ROOF STRUCTURE & COVERING	
D	DOOR	
Е	FINISHING	
F	PAINTING & DECORATION	
G	PLUMBING & SANITARY INSTALLATION-PROVISIONAL	
Н	RISER FOR WATER TANK	
J	MANHOLE, GULLYTRAP, SEPTIC TANK AND SOAK PIT	
K	ELECTRICAL INSTALLATIONS	
L	HANDRAILS TO RAMP	
	TOTAL BUILDING MATERIALS CARRIED TO GENERAL SUMMARY	
	ADD:	
	LABOUR COST CARRIED TO GENERAL SUMMARY : (Improve and Fill the respective	ve Labour form)
	Note:	
	i Refer General Summary for: Preliminary, Transportation and Supervision Cos	ts
	ii. Preliminary cover the following item:	
	- Setting out working tools, Equipments, Temporary toilets, water for the works	<u> </u>
	- Power for the works, Security, store, Materials test, levelling, holdings and re	emoval of rubbis
	iii. Supervision cost depend on guideline of the specific project	

### THE UNITED REPUBLIC OF TANZANIA


### MINISTRY OF EDUCATION SCIENCE AND TECHNOLOGY


IN COLLABORATIONS WITH


PRESIDENT'S OFFICE, REGIONAL ADMINISTRATION AND LOCAL GOVERNMENT


### PROVISION OF PHYSICAL FACILITIES IN PRIMARY SCHOOLS

Ministry of Education, Science and Technology Government City-Mtumba, Afya Street, P.O. Box 10, 40479 DODOMA President's Office, Regional Administration and Local Government. Government City-Mtumba, TAMISEMI Street, P.O. Box 1923, 41185 DODOMA

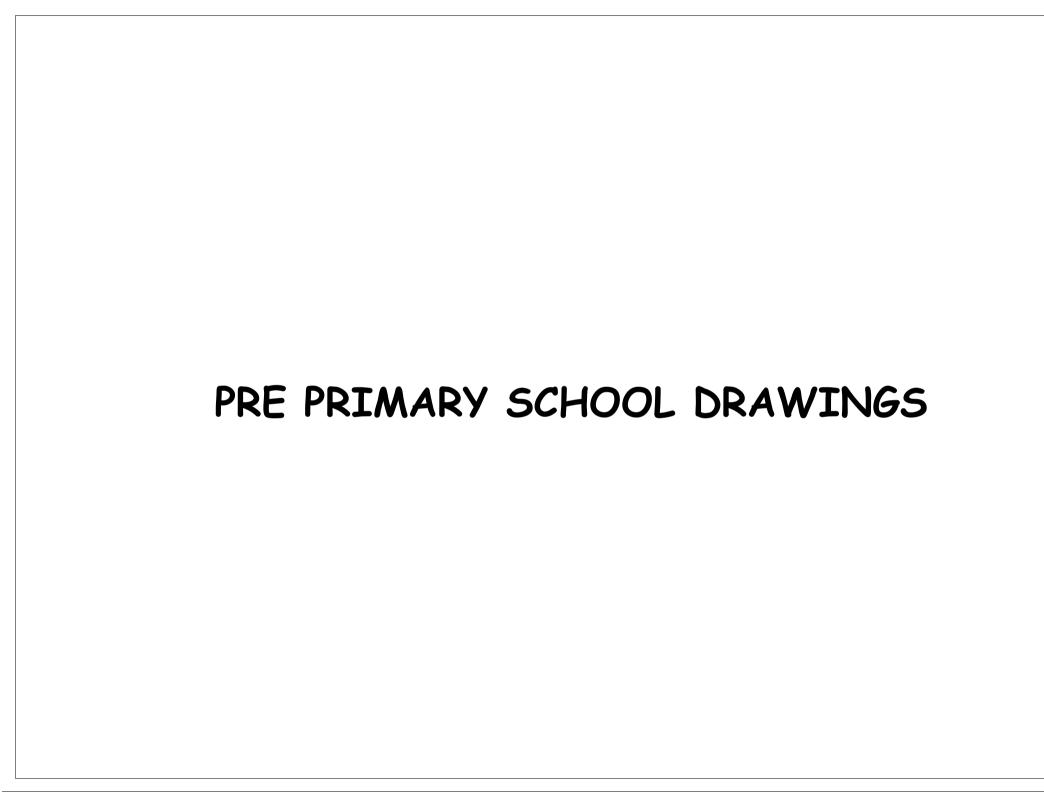

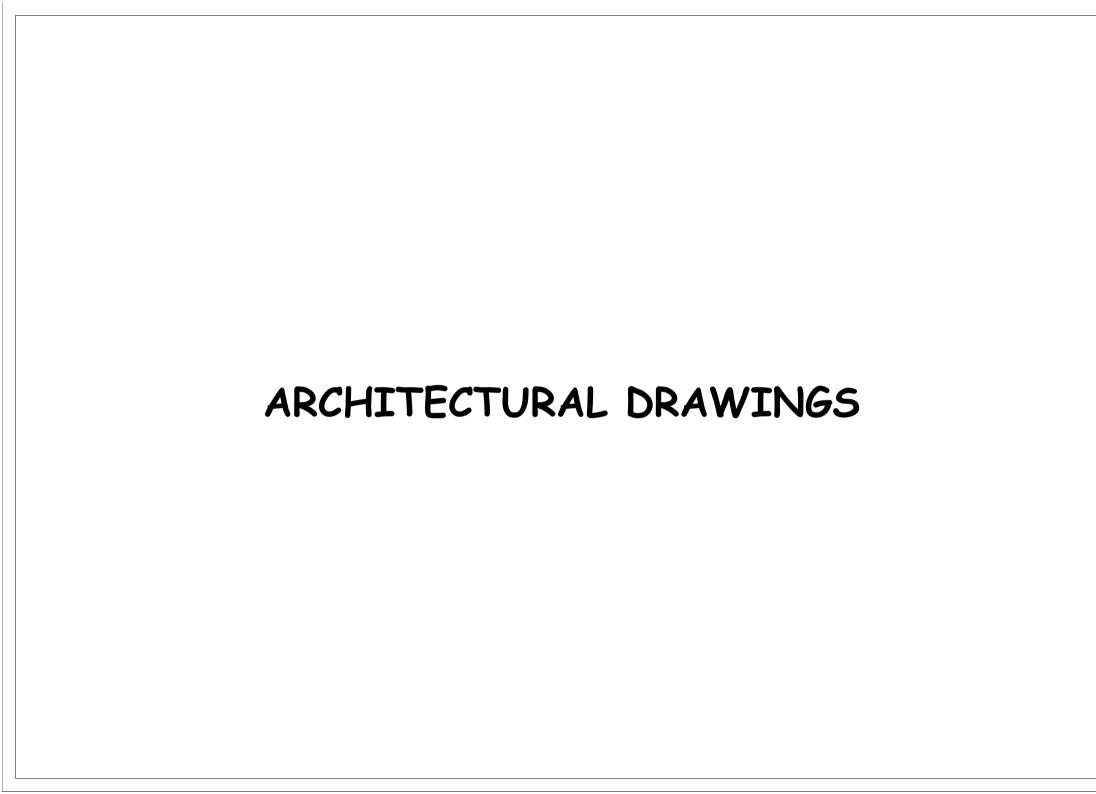

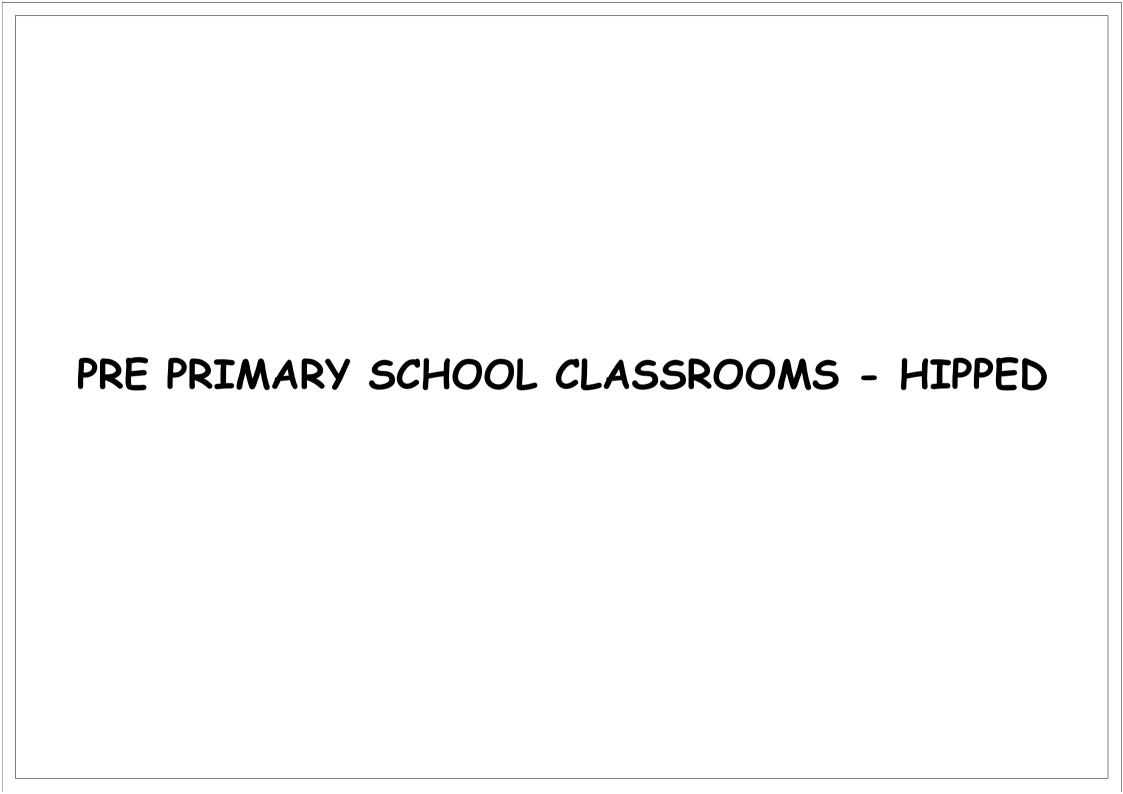

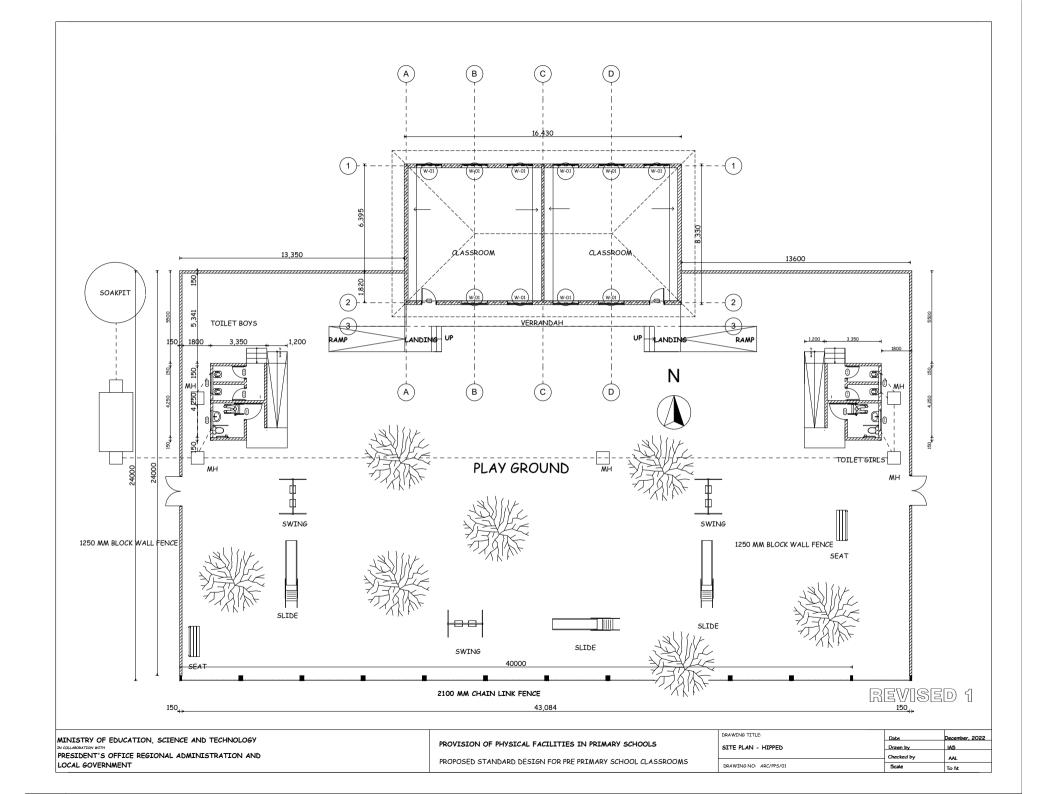

	DOOR & WI	NDOW SCHEDUL	.E
NO.	WIDTH	HEIGHT	TOTAL
D1	900mm	2,500mm	2
W-01	1,500mm	2,000mm	10


8,100

5000 Ltrs rain water

harvest tank

2

RAMP

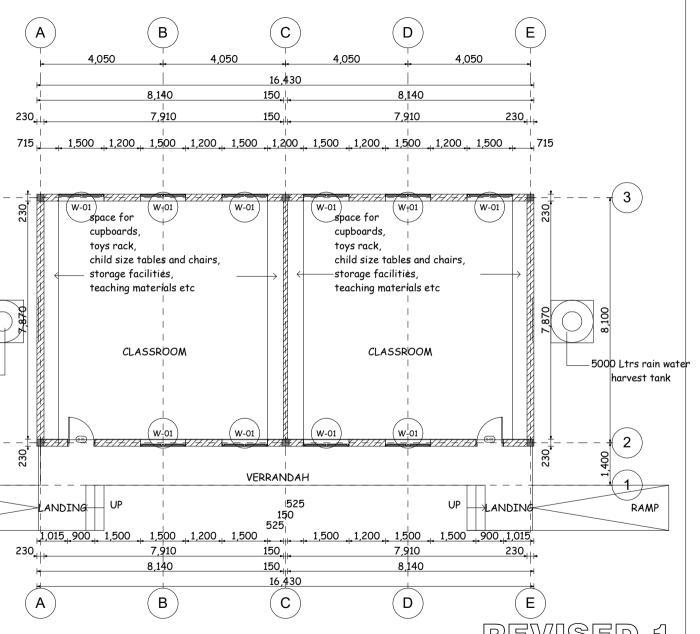

MINISTRY OF EDUCATION, SCIENCE AND TECHNOLOGY IN COLLABORATION WITH

TOTAL FLOOR AREA = 156.5 SQM

PRESIDENT'S OFFICE REGIONAL ADMINISTRATION AND LOCAL GOVERNMENT

PROVISION OF PHYSICAL FACILITIES IN PRIMARY SCHOOLS

PROPOSED STANDARD DESIGN FOR PRE PRIMARY SCHOOL CLASSROOMS

DRAWING TITLE:


FLOOR PLAN - AREA PRONE TO EARTHQUAKE
DRAWING NO: ARC/PPS/02

 KE
 Date
 December, 2022

 Drawn by
 IAS

 Checked by
 AAL

 Scale
 To fit

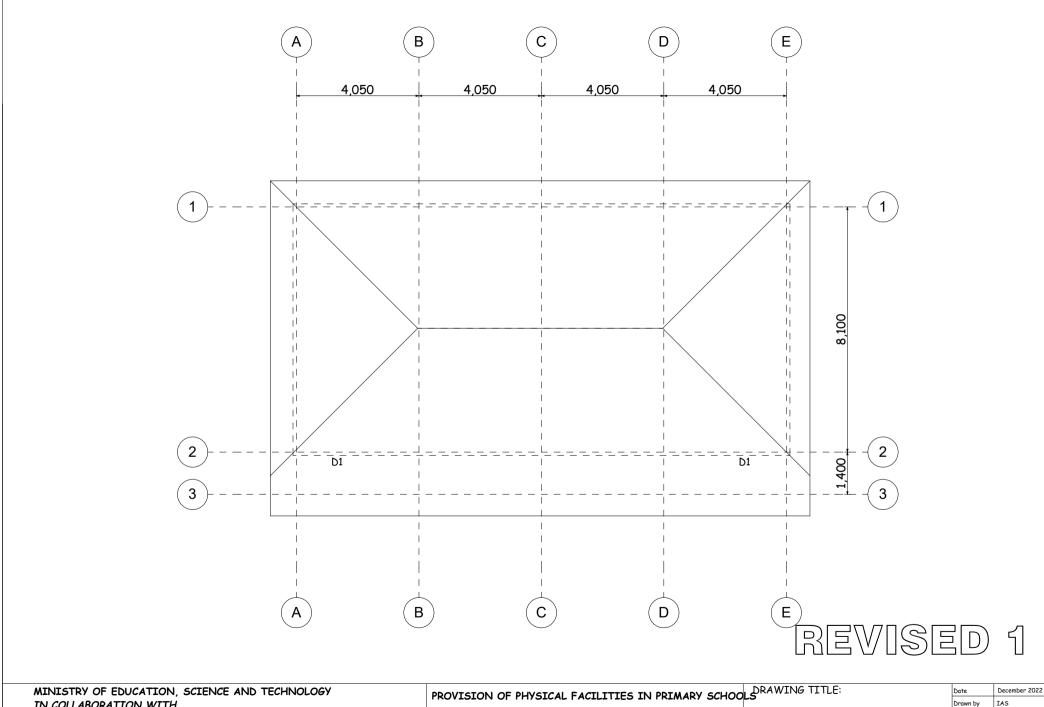



MINISTRY OF EDUCATION, SCIENCE AND TECHNOLOGY IN COLLABORATION WITH PRESIDENT'S OFFICE REGIONAL ADMINISTRATION AND LOCAL GOVERNMENT


PROPOSED STANDARD DESIGN FOR PRE PRIMARY SCHOOL CLASSROOMS

ROOF PLAN - AREA PRONE TO EARTHQUAKE DRAWING NO: ARC/PPS/03


Date	December 2022
Drawn by	IAS
Checked by	AAL
Scale	To fit

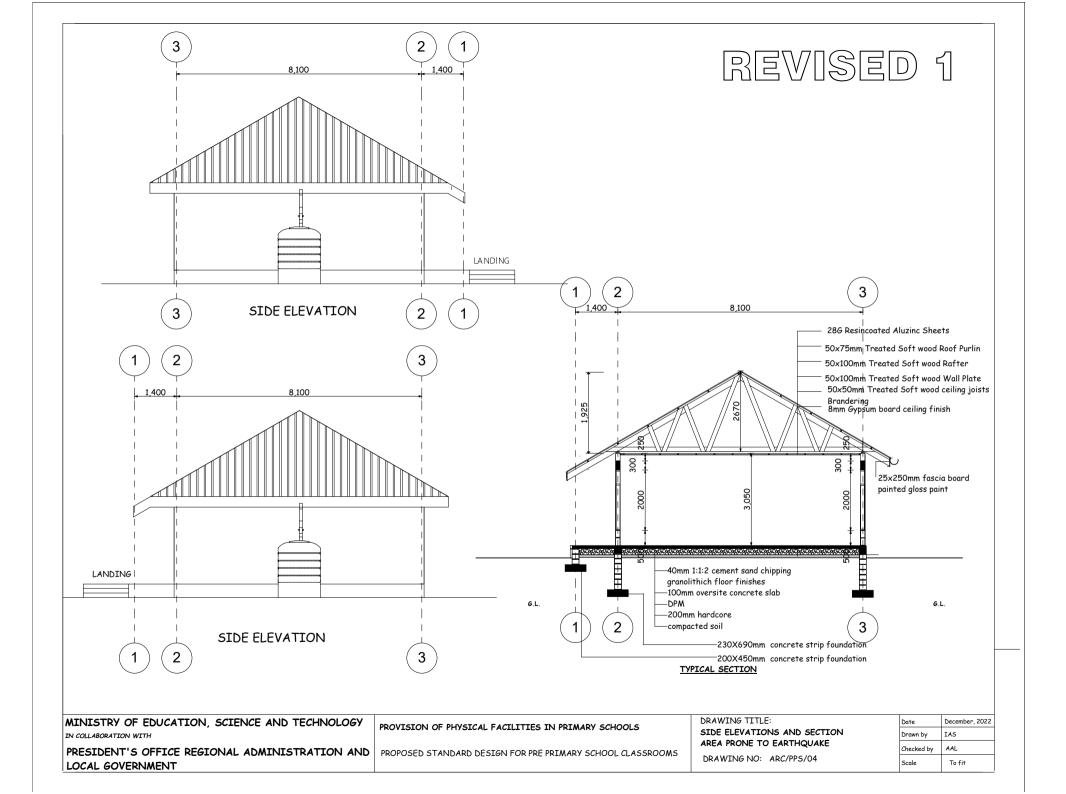

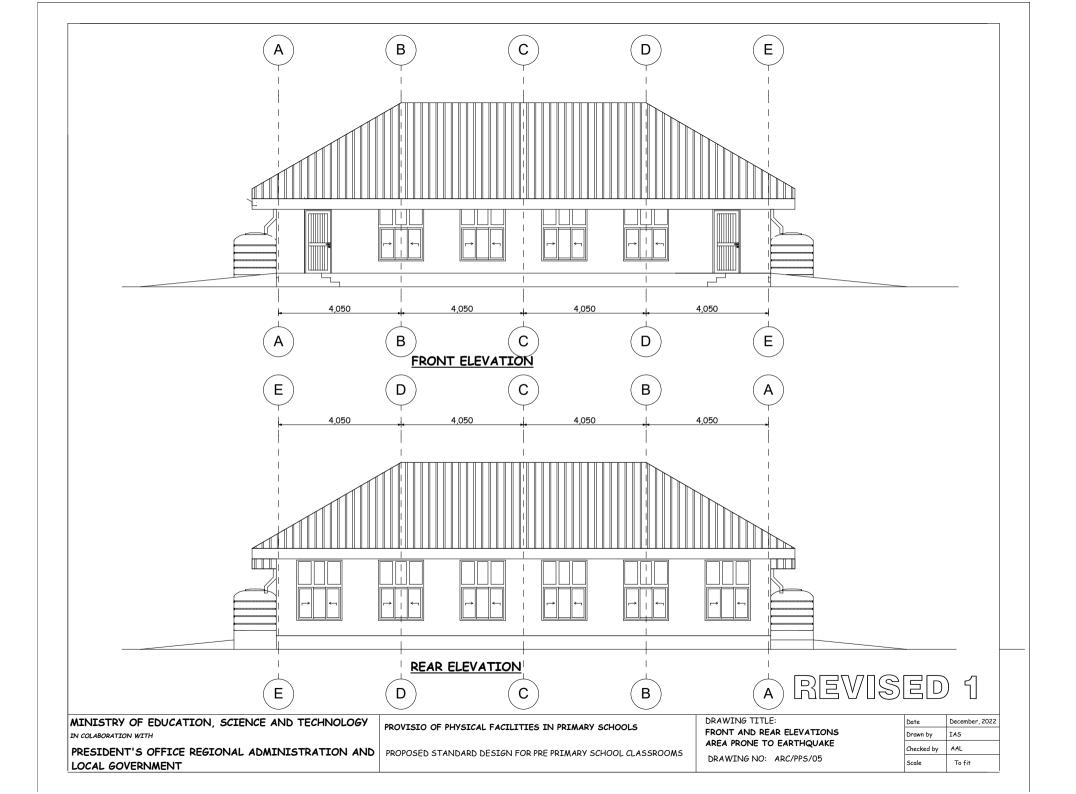

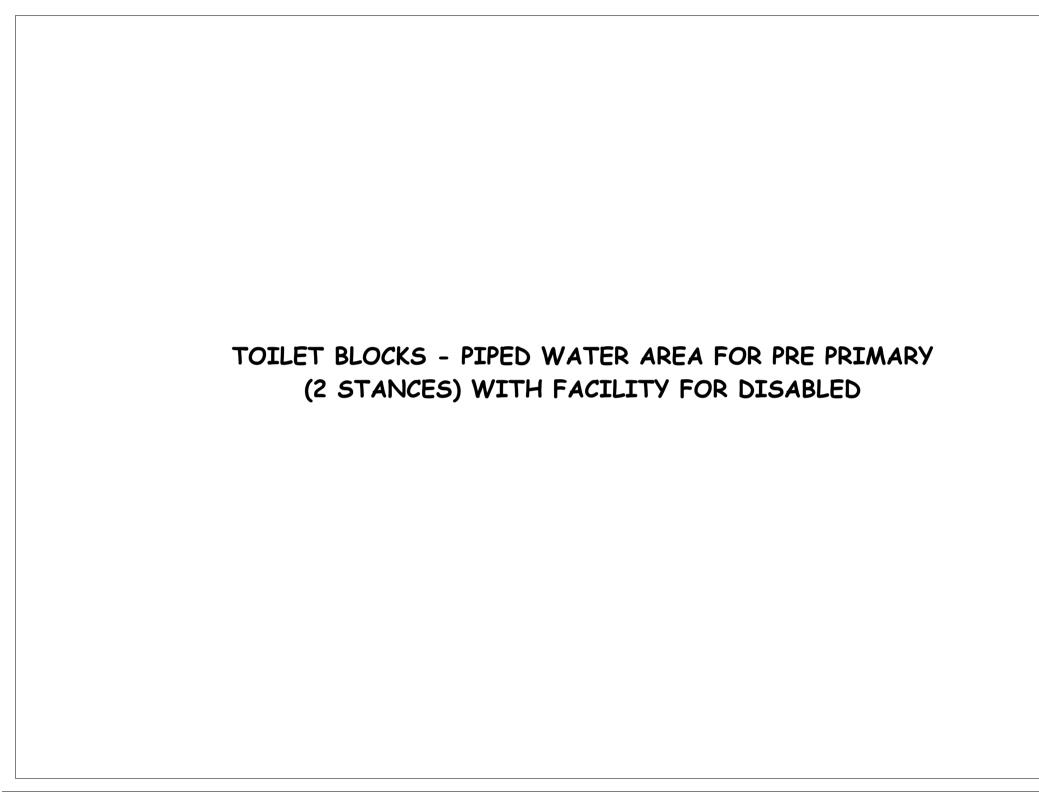

	WINDOW SCH	FDULE
	EHEIGHT X WIDTH	
W-01	750 X 1200	02
01		
	DOOR SCHEDU	LE
DOOR TYPE	HEIGHT X WIDTH	QUANTITY
D-02	2100 X 750	02
D-03	2100 X 1000	01

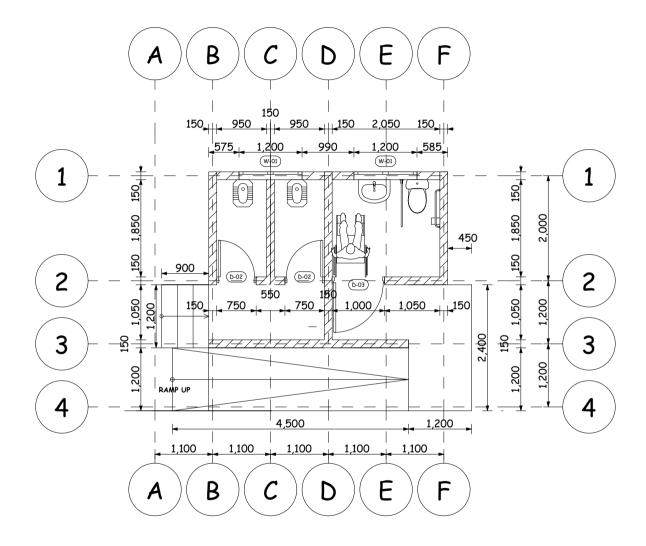

MINISTRY OF EDUCATION, SCIENCE AND TECHNOLOGY
IN COLLABORATION WITH

PRESIDENT'S OFFICE REGIONAL ADMINISTRATION AND LOCAL GOVERNMENT


PROVISION OF PHYSICAL FACILITIES IN PRIMARY SCHOOLS

DRAWING TITLE

TOILET FOR PRE PRIMARY SCHOOL - FLOOR PLAN

DRAWING NO. BP/ARC/TLT-WG80/01

DRAWN BY J.R CHECKED BY I.A.S. SCALE 1;200 DEC,2022

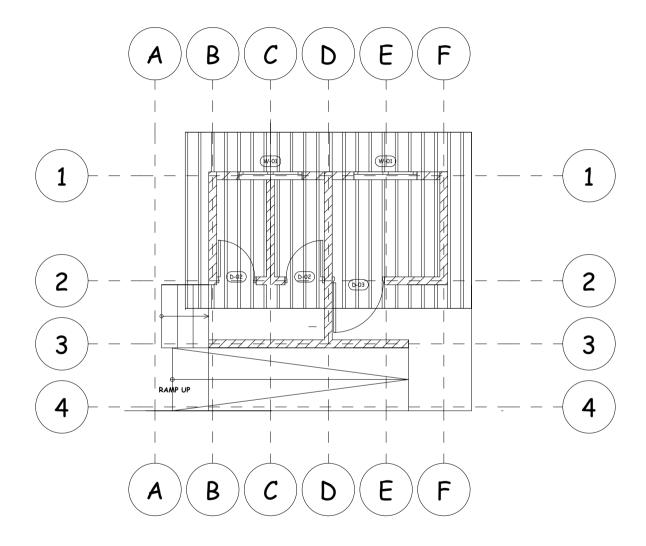

MINISTRY OF EDUCATION, SCIENCE AND TECHNOLOGY IN COLLABORATION WITH

PRESIDENT'S OFFICE REGIONAL ADMINISTRATION AND LOCAL GOVERNMENT


PROVISION OF PHYSICAL FACILITIES IN PRIMARY SCHOOLS

DRAWING TITLE

TOILET FOR PRE PRIMARY SCHOOL - ROOF PLAN

DRAWING NO. BP/ARC/TLT-WG80/01

DRAWN BY J.R CHECKED BY I.A.S. SCALE 1;200 DEC,2022

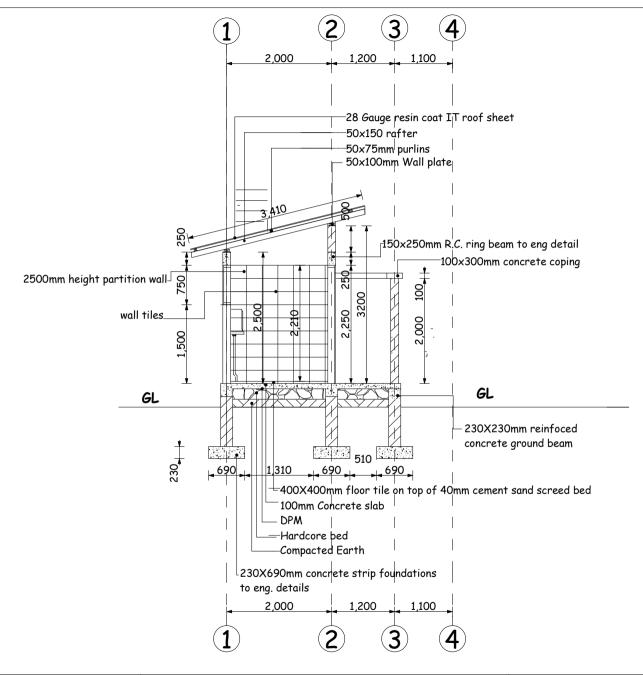

MINISTRY OF EDUCATION, SCIENCE AND TECHNOLOGY IN COLLABORATION WITH

PRESIDENT'S OFFICE REGIONAL ADMINISTRATION AND LOCAL GOVERNMENT


PROVISION OF PHYSICAL FACILITIES IN PRIMARY SCHOOLS

DRAWING TITLE

TOILET FOR PRE PRIMARY SCHOOL - TYPICAL SECTION

DRAWING NO. BP/ARC/TLT-WG80/01

DRAWN BY J.R CHECKED BY I.A.S. SCALE 1;200 DEC,2022

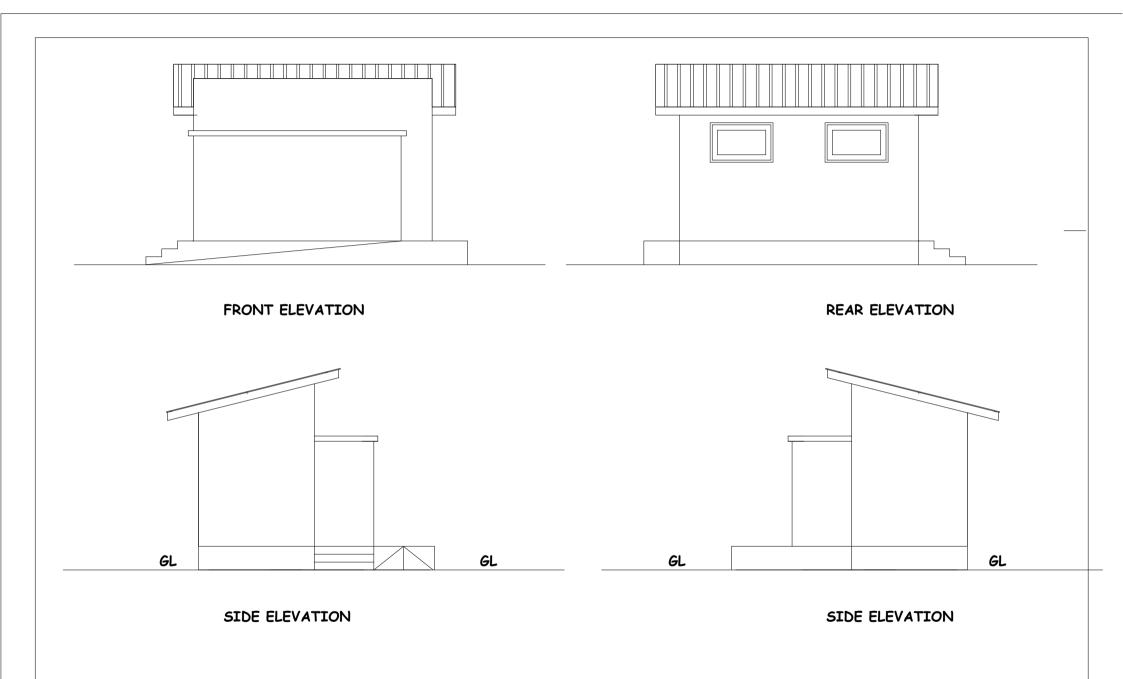

MINISTRY OF EDUCATION, SCIENCE AND TECHNOLOGY IN COLLABORATION WITH

PRESIDENT'S OFFICE REGIONAL ADMINISTRATION AND LOCAL GOVERNMENT

PROVISION OF PHYSICAL FACILITIES IN PRIMARY SCHOOLS

DRAWING TITLE

TOILET FOR PRE PRIMARY SCHOOL - ELEVATIONS


DRAWING NO. BP/ARC/TLT-WG80/01


DRAWN BY J.R CHECKED BY I.A.S. SCALE 1:200 DEC,2022


## STRUCTURAL DRAWINGS


FOR


# RIMARY CLASSROOM BLOCK TYPE A - 2 ROOMS - HIPPED **AREA PRONE TO EARTHQUAKE**

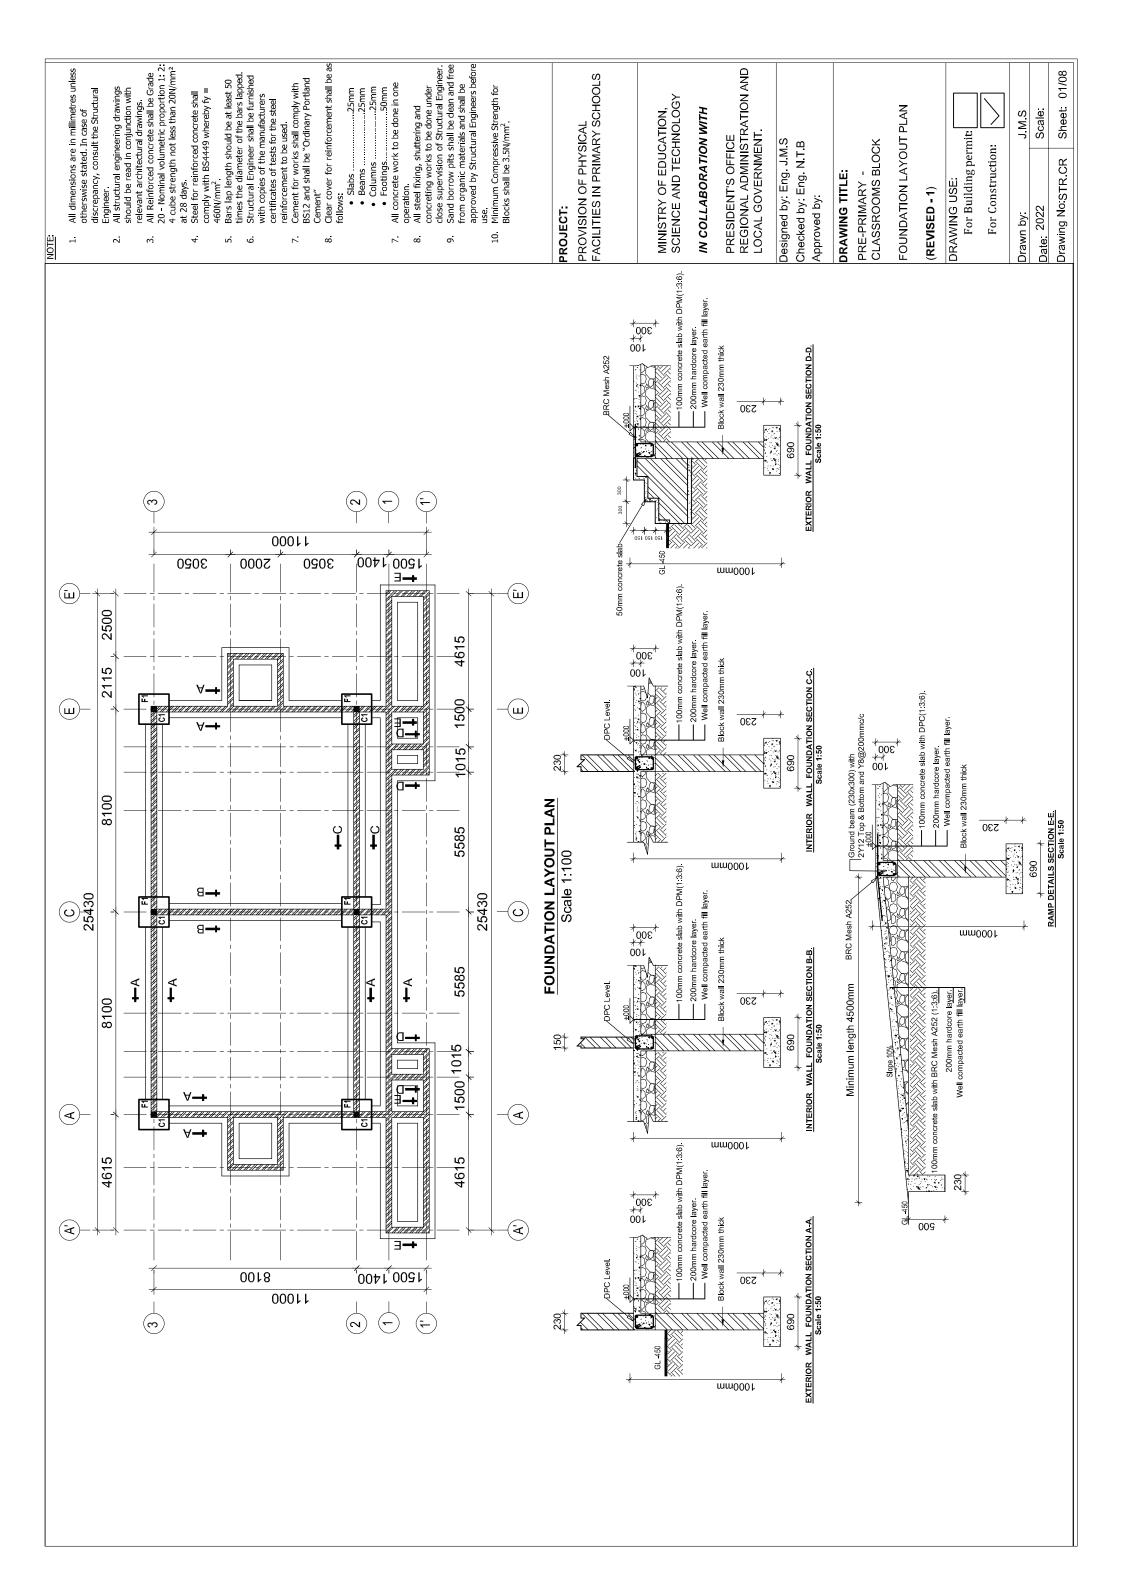


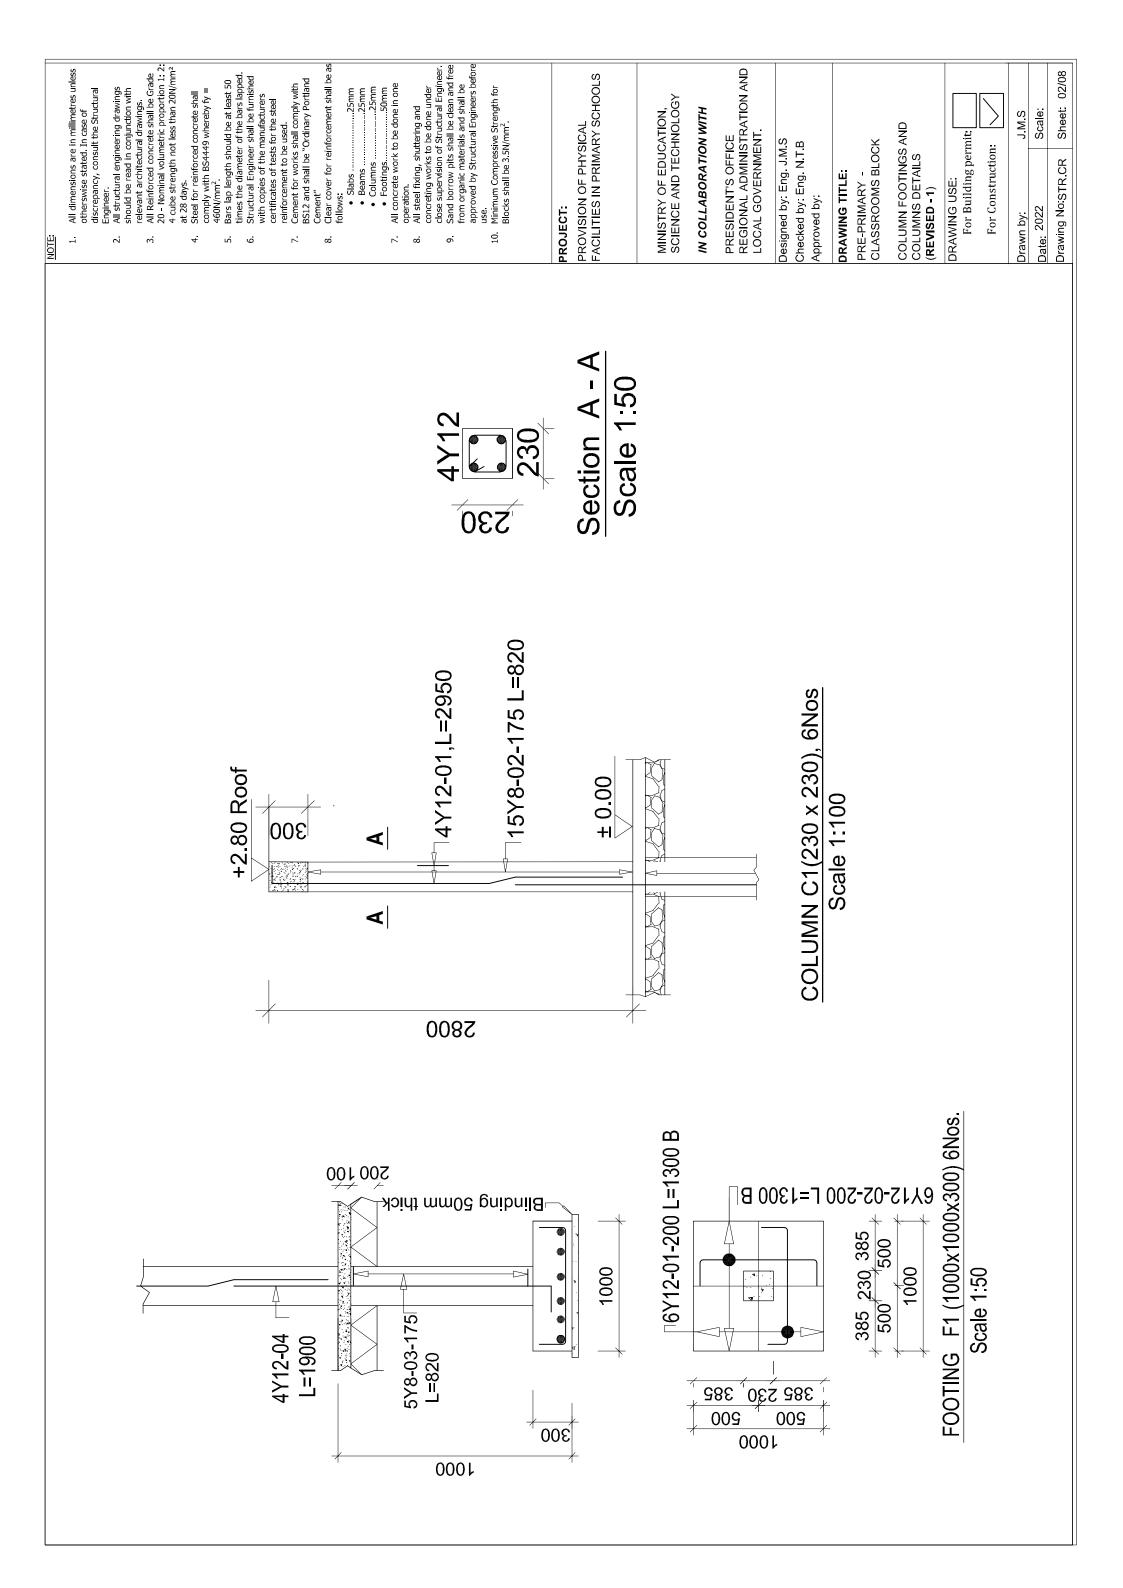


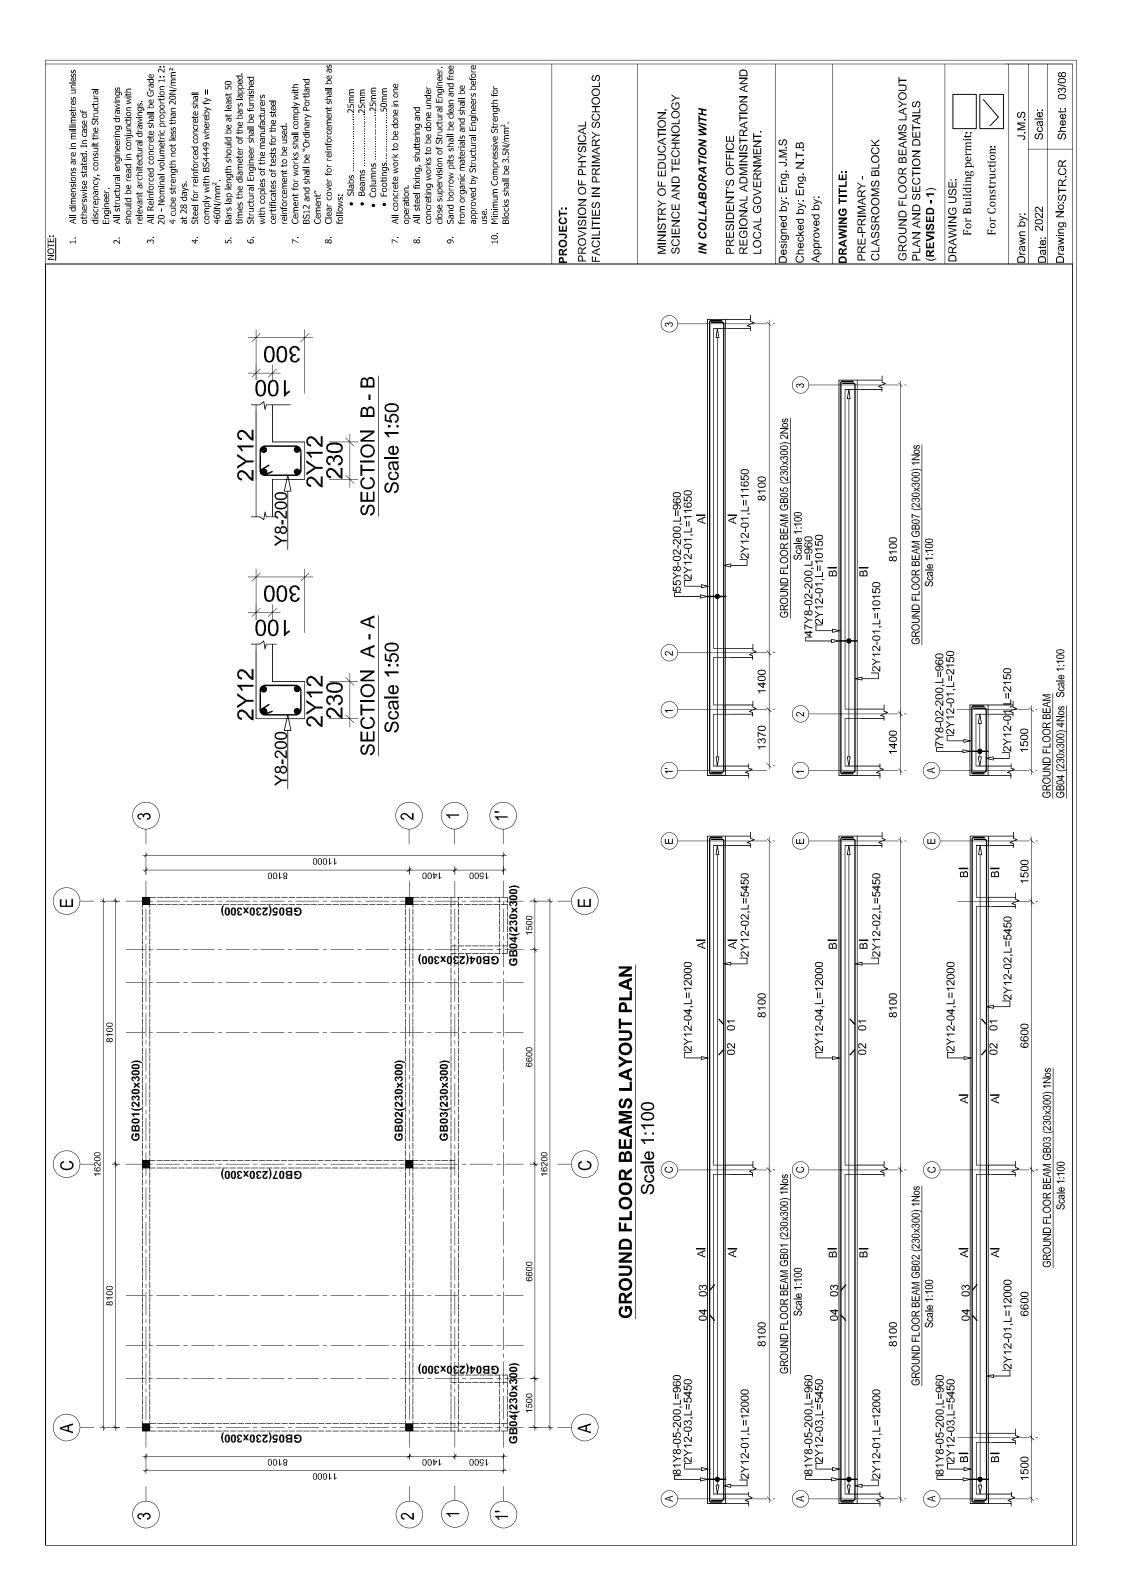

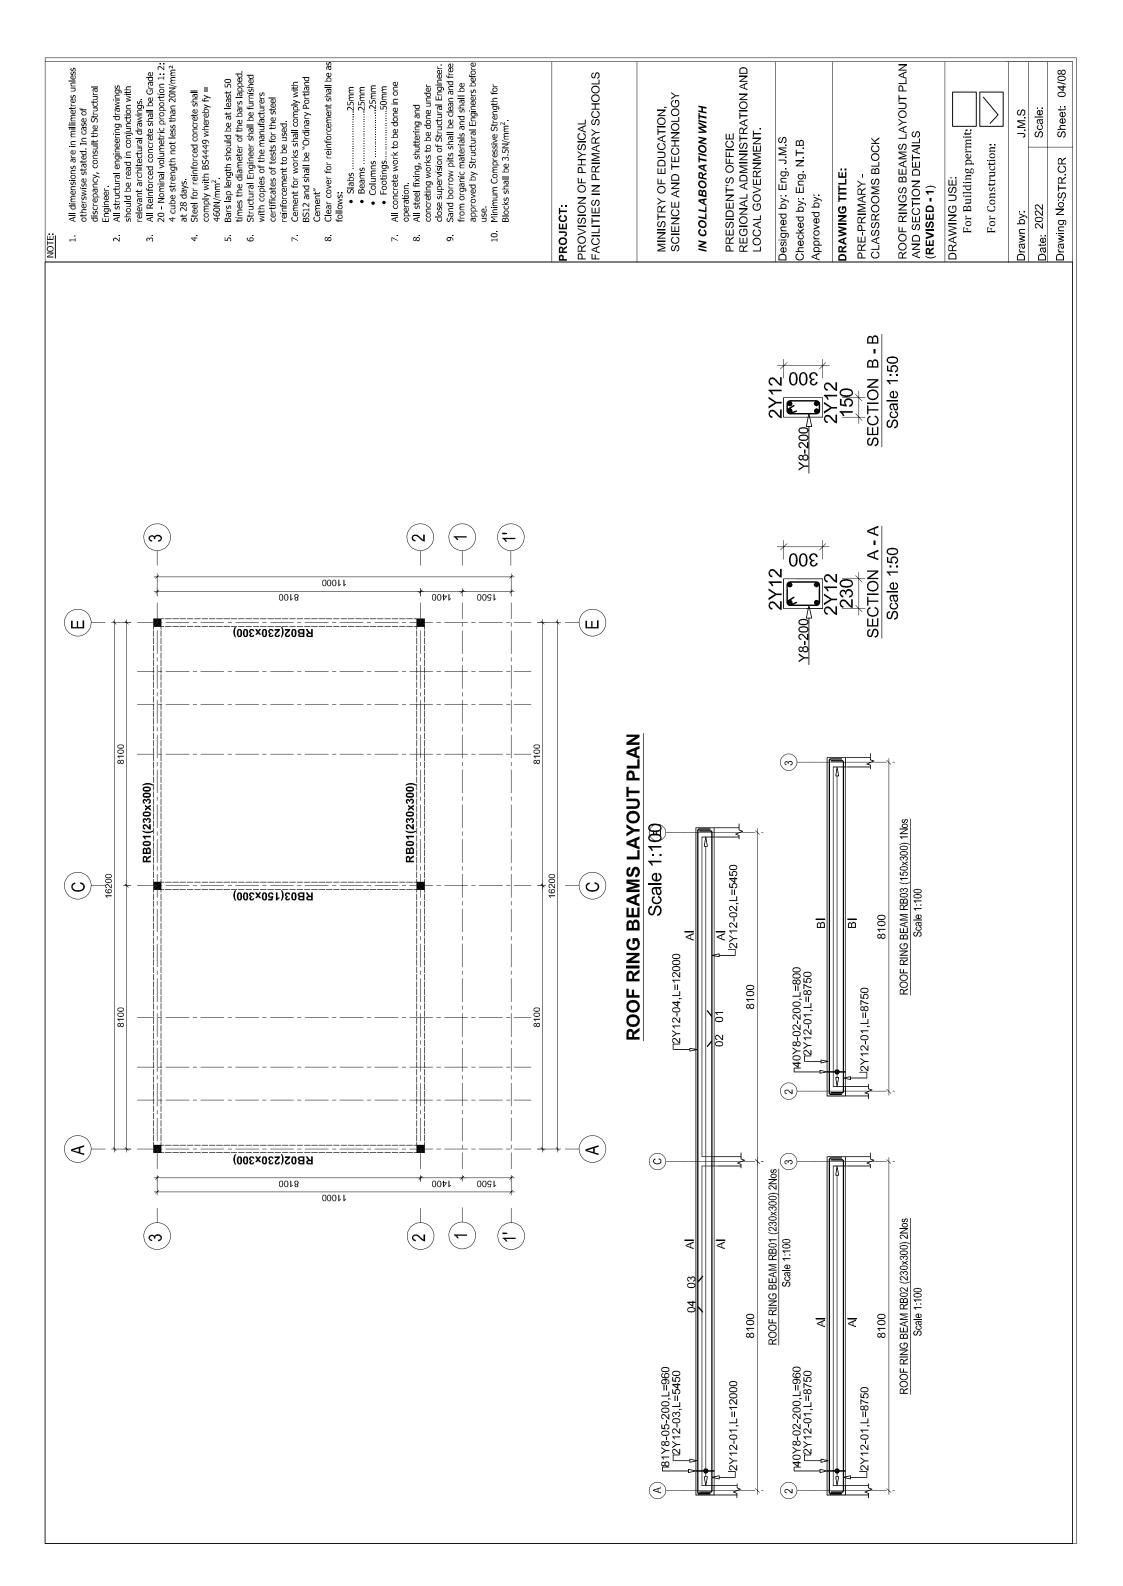

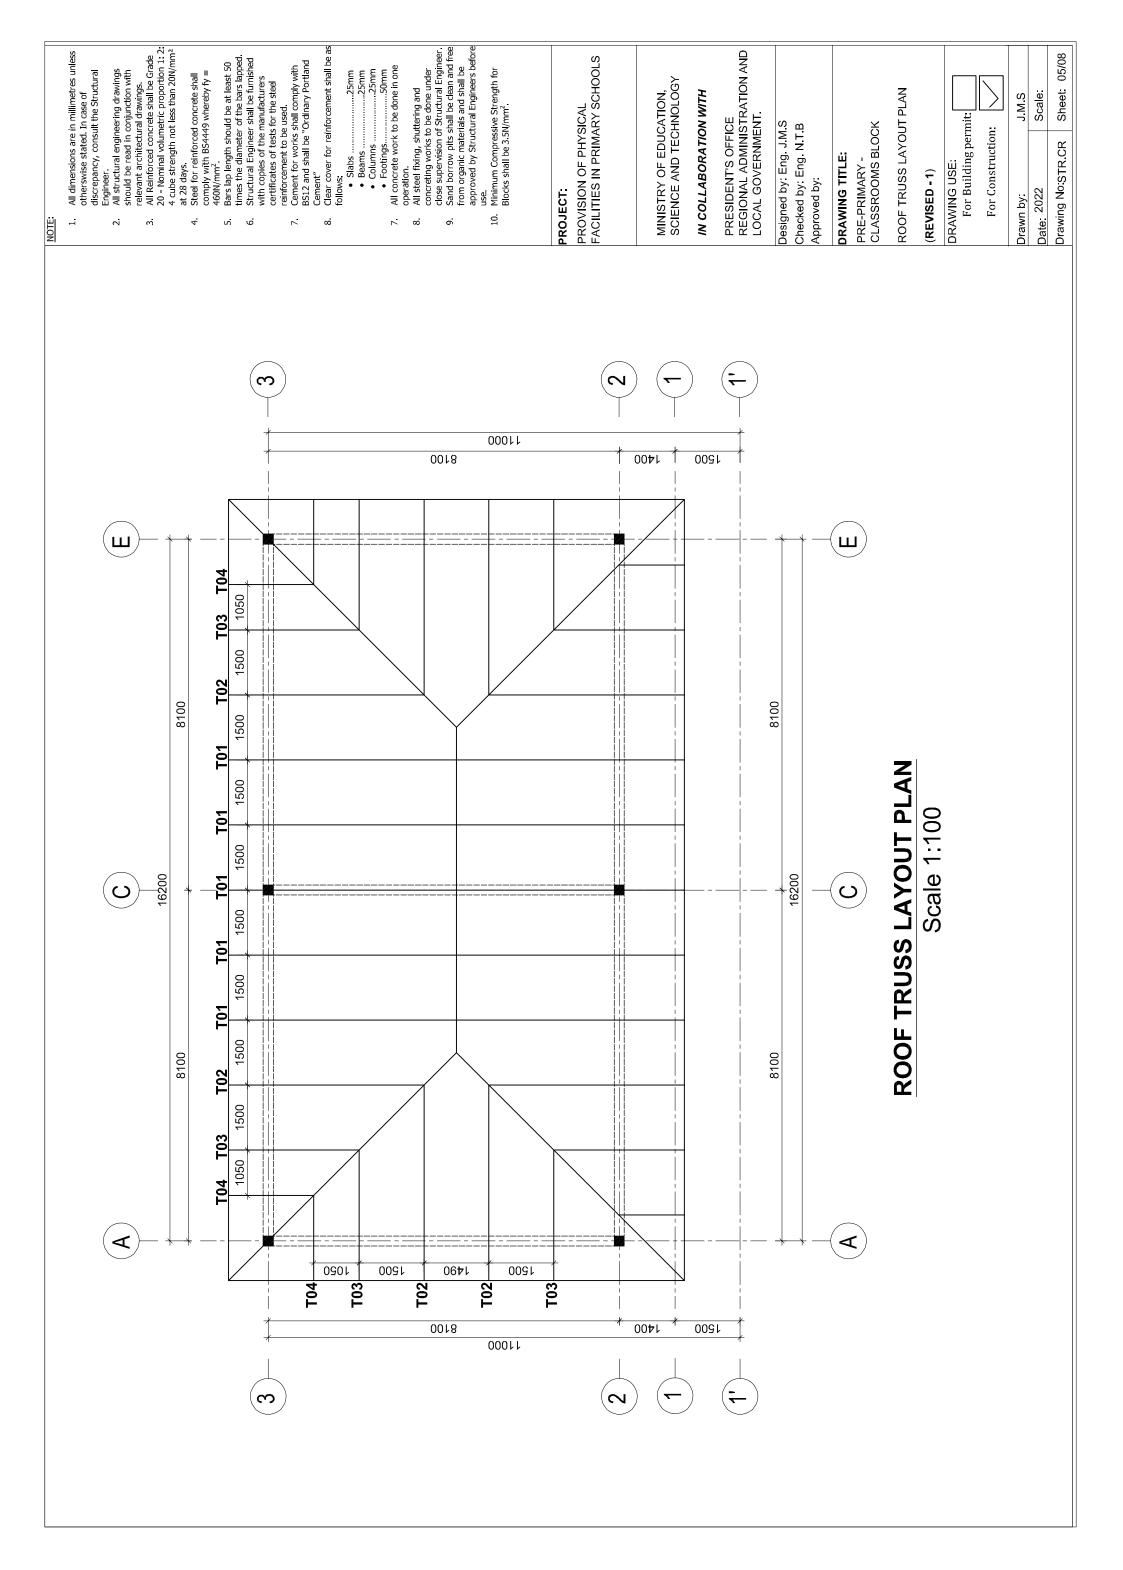

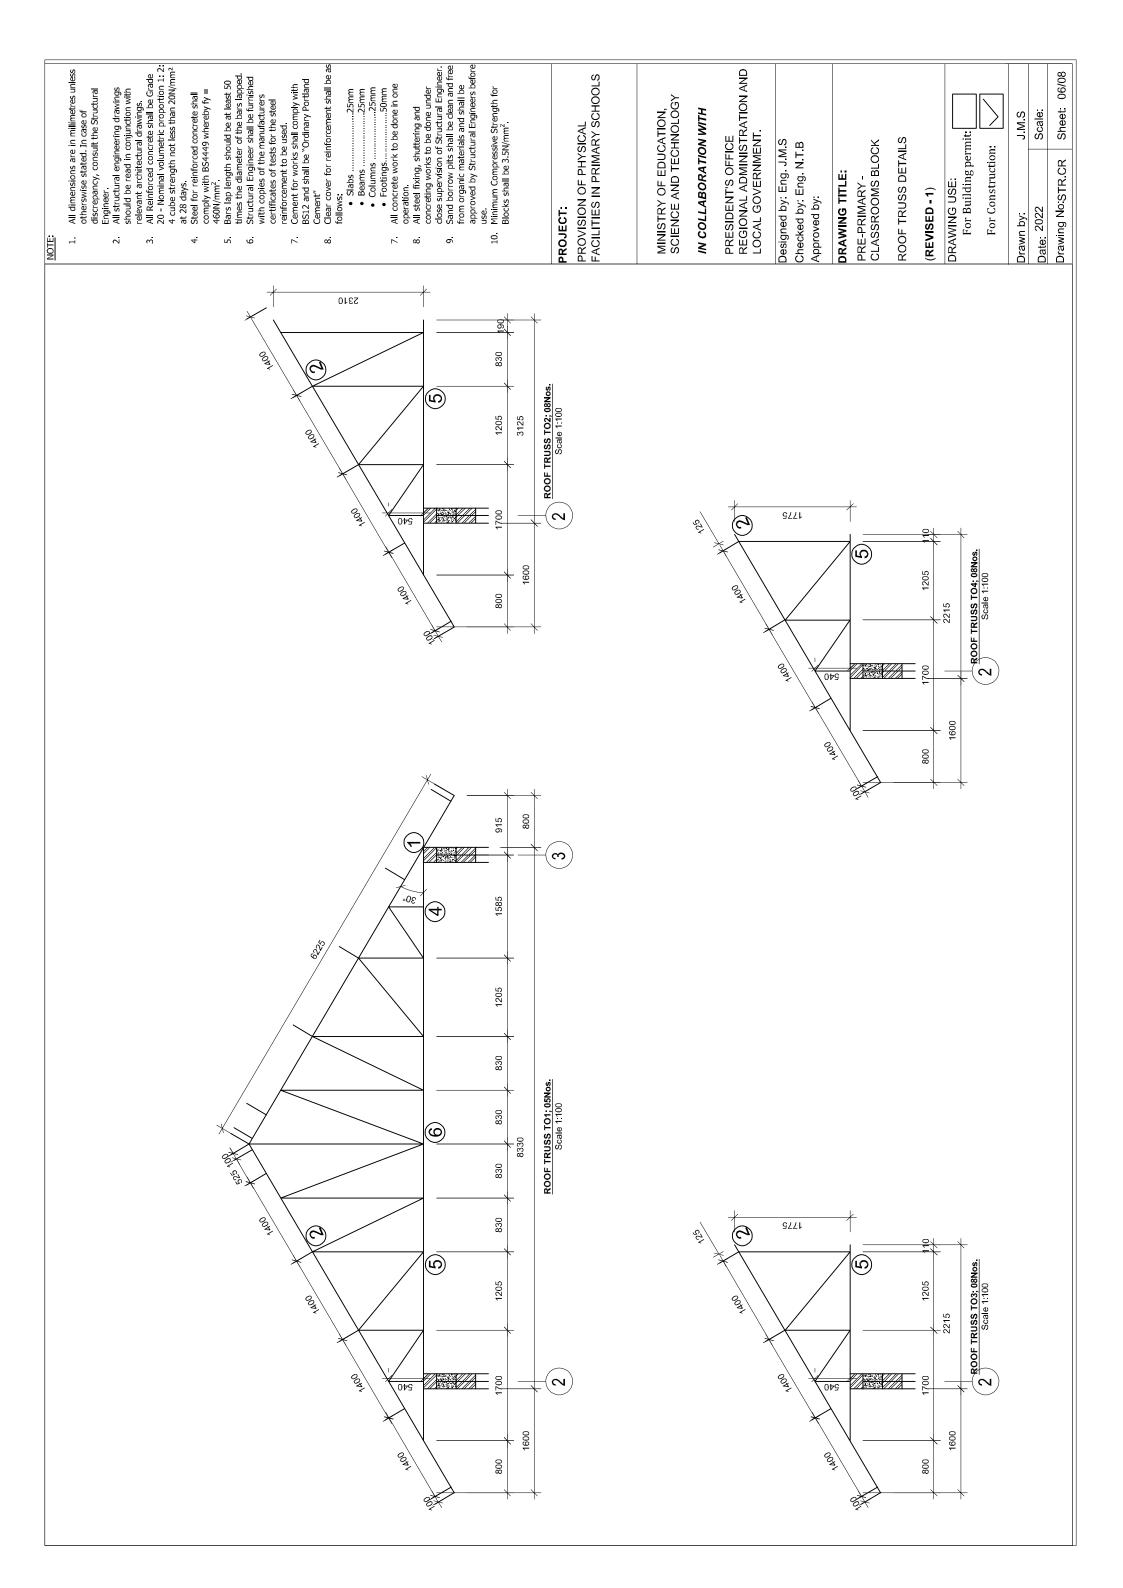

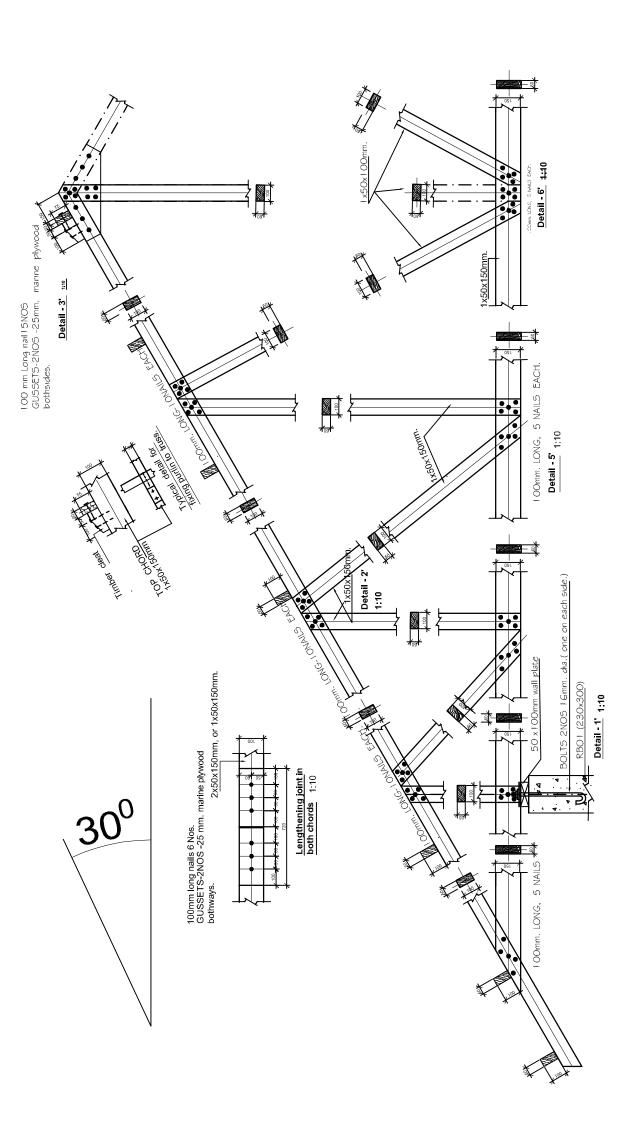

# TYPICAL TRUSS CONNECTIONS DETAIL

NOTE:

- All dimensions are in millimetres unless otherswise stated. In case of discrepancy, consult the Structural
- All structural engineering drawings should be read in conjunction with relevant architectural drawings.

  All Reinforced concrete shall be Grade 20 Nominal volumetric proportion 1: 2: 4 cube strength not less than 20N/mm² at 28 days.

  Steel for reinforced concrete shall comply with BS4449 whereby fy = 460N/mm².
  - 4.
- Ŋ 9
- Bars lap length should be at least 50 times the diameter of the bars lapped. Structural Engineer shall be furnished with copies of the manufacturers certificates of tests for the steel reinforcement to be used. Cement for works shall comply with BS12 and shall be "Ordinary Portland Cement"
  - - Slabs 25mm
       Beams 25mm
       Columns 25mm
       Footings 50mm
      All concrete work to be done in one

      - 7 œ
- operation.

  All steel fixing, shuttering and concreting works to be done under close supervision of Structural Engineer. Sand borrow pits shall be dean and free from organic materials and shall be approved by Structural Engineers before 9
  - Minimum Compressive Strength for Blocks shall be 3.5N/mm<sup>2</sup>. 10

### PROJECT:

PROVISION OF PHYSICAL FACILITIES IN PRIMARY SCHOOLS

MINISTRY OF EDUCATION, SCIENCE AND TECHNOLOGY

### IN COLLABORATION WITH

PRESIDENT'S OFFICE REGIONAL ADMINISTRATION AND LOCAL GOVERNMENT.

Designed by: Eng. J.M.S Checked by: Eng. N.T.B Approved by:

### DRAWING TITLE:

PRE-PRIMARY -CLASSROOMS BLOCK

ROOF TRUSS CONNECTION DETAILS (REVISED - 1)

DRAWING USE:

For Building permit	For Construction:	

Drawn by:	J.M.S
Date: 2022	Scale:
Drawing No:STR.CR	Sheet: 07/08

		NUMBER OF MEMBER	7	2	Ø	01	5	5	8	-	-	Ø	7	8	5	N	8								
	Page 2/2	MEMBER TYPE	ROOF BEAM 1	ROOF BEAM 1	ROOF BEAM 1	ROOF BEAM 1	ROOF BEAM 1	ROOF BEAM 2	ROOF BEAM 2	ROOF BEAM 3	ROOF BEAM 3	COLUMN	COLUMN	COLUMN STARTER	COLUMN	COLUMN	COLUMN								
		NOTES																							
	AOOMS BLOCK	SKETCH OF BAR DIMENSIONS IN (mm)	11750	<del>1020</del>	00025	11750	1097	11750	10921	2500	11/20	100 1 1 1 1 1 1 1 1 1 1 1 1 1 1 1 1 1 1	11750	10921	95200 0931	11750	103×1	1050	105×1	1000	180	1092	200 t NEO t		
	PROVISION OF PHYSICAL FACILITIES FOR PRIMARY SCHOOLS - PRE-PRIMARY CLASSROOMS BLOCK (GROUND FLOOR BEAMS)	TOTAL LENGTH (π)	. 24	10.9	10.9	. 54	77.76	. 54	- 10.9	10.9	- 24	77.76	- 24		- 10.9	. 54	57.77	34.4	26.88	. 26	105.6	40.6	45.12		
Schedule	AARY SCHOOLS FLOOR BEAM	NO.OF BARS	2	5	2	2	18	2	2	2	2	18	2	2	2	5	18	16	28	ω	110	4	47		
Bar Bending Schedule	ACILITIES FOR PRIN (GROUNI	LENGTH OF EACH BAR (mm)	12000	5450	5450	12000	096	12000	5450	5450	12000	096	12000	5450	5450	12000	096	2150	096	11500	096	10150	096		
	NOF PHYSICAL F.	BAR TYPE AND SIZE (mm)	Y12	Y12	Y12	Y12	γ8	Y12	Y12	Y12	Y12	γ8	Y12	Y12	Y12	Y12	γ8	Y12	٧8	Y12	γ8	Y12	Y8		
	PROVISIC	MARK No.	10	02	03	04	05	10	02	03	04	05	10	02	03	04	05	10	02	10	02	10	02		
		NUMBER OF MEMBER	<del></del>	<del>-</del>	7-	7-	<del>1=</del>	<del>1=</del>	<del></del>	<del>1=</del>	F	=	<del>-</del>	<del>1=</del>	F	<del>-</del>	<del>-</del>	4	4	8	2	F	1		
	Page 1/2	MEMBER TYPE	GROUND BEAM1	GROUND BEAM1	GROUND BEAM1	GROUND BEAM1	GROUND BEAM 1	GROUND BEAM 2	GROUND BEAM 2	GROUND BEAM2	GROUND BEAM2	GROUND BEAM2	GROUND BEAM3	GROUND BEAM3	GROUND BEAM3	GROUND BEAM3	GROUND BEAM3	GROUND BEAM 4	GROUND BEAM 4	GROUND BEAM 5	GROUND BEAM 5	GROUND BEAM 6	GROUND BEAM 6		

		NOTES																				
	300MS BLOCK	SKETCH OF BAR DIMENSIONS IN	11750	1097	2500	11750	20 05 1 180 180 1	<del>1020</del>	50 50 180	8250	1097 1097	10021	10021	50 S	1600	2770	180					
0	PROVISION OF PHYSICAL FACILITIES FOR PRIMARY SCHOOLS - PRE-PRIMARY CLASSROOMS BLOCK (COLUMN FOOTINGS, COLUMNS AND ROOF RING BEAMS)	TOTAL LENGTH (m)	48	21.8	21.8	48	155.52	- 02	76.8	35	32	15.6		8.2	15.2	. 23.6	24.6					
Schedule	AARY SCHOOL: DLUMNS AND R	NO.OF BARS	4	4	4	4	162	œ	80	4	40	12	12	10	œ	80	30					
Bar Bending Schedule	ACILITIES FOR PRINJAN FOOTINGS, CO	LENGTH OF EACH BAR (mm)	12000	5450	5450	12000	096	8750	096	8750	800	1300	1300	820	1900	2950	820					
	ON OF PHYSICAL F	BAR TYPE AND SIZE (mm)	Y12	Y12	Y12	Y12	٨8	Y12	Y8	Y12	γ8	Y12	Y12	Y8	Y12	Y12	Y8					
	PROVISIO	MARK No.	10	02	03	04	05	10	02	01	02	10	02	03	04	10	05					
		NUMBER OF MEMBER	Ø	2	2	2	2	2	2	1	-	Ø	Ø	2	2	2	23					
6/6 680	49c 2/2	MBER TYPE	OOF BEAM 1	DOF BEAM 1	OOF BEAM 1	OOF BEAM 1	DOF BEAM 1	OOF BEAM 2	OOF BEAM 2	OOF BEAM 3	OOF BEAM 3	COLUMN FOOTING	COLUMN FOOTING	COLUMN STARTER	COLUMN STARTER	COLUMN	COLUMN					

PROVISION OF PHYSICAL FACILITIES IN PRIMARY SCHOOLS

PROJECT:

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PRESIDENT'S OFFICE REGIONAL ADMINISTRATION AND LOCAL GOVERNMENT.

Designed by: Eng. J.M.S. Checked by: Eng. N.T.B

MINISTRY OF EDUCATION, SCIENCE AND TECHNOLOGY

IN COLLABORATION WITH

GROUND FLOOR BEAMS AND ROOF RING BEAMS BAR BENDING SCHEDULES (**REVISED - 1**)

PRE-PRIMARY -CLASSROOMS BLOCK

DRAWING TITLE:

Approved by:

DRAWING USE: For Building permit:

For Construction:

Sheet: 08/08

Drawing No.STR.CR

Scale:

Date: 2022

Drawn by:

JMS

6

7 8

All dimensions are in millimetres unless otherswise stated. In case of discrepancy, consult the Structural Engineer.

All structural engineering drawings should be read in conjunction with relevant architectural drawings.

All Reinforced concrete shall be Grade 20 - Nominal volumetric proportion 1: 2: 4 cube strength not less than 20N/mm² at 28 days.

Steel for reinforced concrete shall comply with BS449 whereby fy = 460N/mm².

Bars lap length should be at least 50 times the diameter of the bars lapped. Structural Engineer shall be furnished with copies of the manufacturers certificates of tests for the steel reinforcement to be used. Cement for works shall comply with BS12 and shall be "Ordinary Portland Cement".

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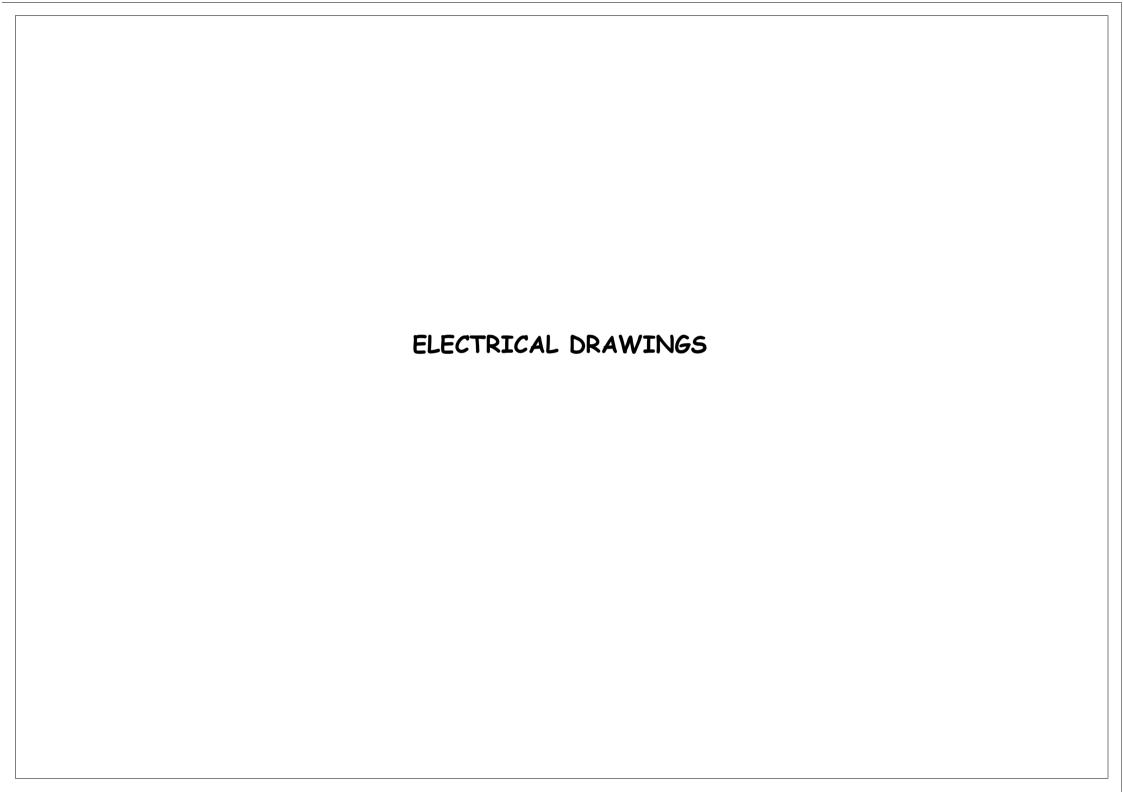
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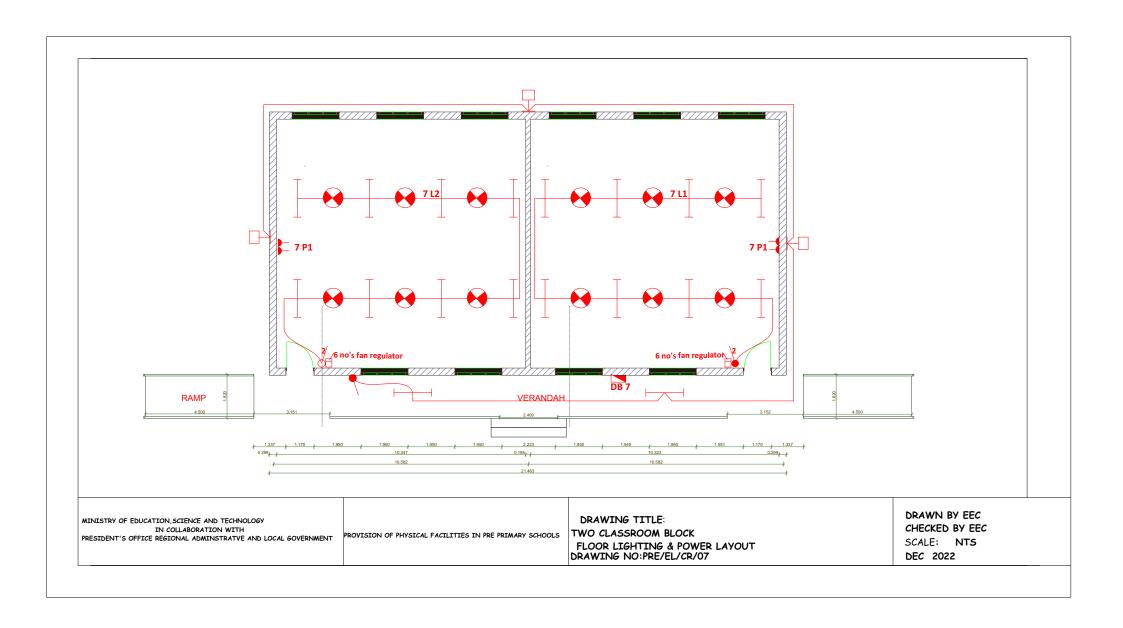
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NOTE

D 1/0				Bar Bendin	g Schedul	е		
Page 1/2		PROVISI	ION OF PHYSICAL		PRIMARY SCHOOND FLOOR BEAM		CLASSROOMS BLOCK	
MEMBER TYPE	NUMBER OF MEMBER	MARK No.	BAR TYPE AND SIZE (mm)	LENGTH OF EACH BAR (mm)	NO.OF BARS	TOTAL LENGTH (m)	SKETCH OF BAR DIMENSIONS IN (mm)	NOTES
GROUND BEAM 1	1	01	Y12	12000	2	24	11750	
GROUND BEAM 1	1	02	Y12	5450	2	10.9	5200	
GROUND BEAM 1	1	03	Y12	5450	2	10.9	5200	
GROUND BEAM 1	1	04	Y12	12000	2	24	11750	
GROUND BEAM 1	1	05	Y8	960	81	77.76	50 50 00 20 180	
GROUND BEAM 2	1	01	Y12	12000	2	24	11750	
GROUND BEAM 2	1	02	Y12	5450	2	10.9	5200	
GROUND BEAM 2	1	03	Y12	5450	2	10.9	5200	
GROUND BEAM 2	1	04	Y12	12000	2	24	11750	
GROUND BEAM 2	1	05	Y8	960	81	77.76	50 000	
GROUND BEAM 3	1	01	Y12	12000	2	24	11750	
GROUND BEAM 3	1	02	Y12	5450	2	10.9	5200	
GROUND BEAM 3	1	03	Y12	5450	2	10.9	5200	
GROUND BEAM 3	1	04	Y12	12000	2	24	11750	
GROUND BEAM 3	1	05	Y8	960	81	77.76	50 50 000 180	
GROUND BEAM 4	4	01	Y12	2150	16	34.4	1650	
GROUND BEAM 4	4	02	Y8	960	28	26.88	50 50 00 20 180	
GROUND BEAM 5	2	01	Y12	11500	8	92	11000	
GROUND BEAM 5	2	02	Y8	960	110	105.6	50 50 000 180	
GROUND BEAM 6	1	01	Y12	10150	4	40.6	9650	
GROUND BEAM 6	1	02	Y8	960	47	45.12	50 50 00 00 00 00 00 00 00 00 00 00 00 0	
							+	

				Bar Bendin	g Schedul	е			
Page 2/2		PROVISI				OLS - PRE-PRIMARY C ROOF RING BEAMS)	ELASSROOMS BLOCK		
MEMBER TYPE	NUMBER OF MEMBER	MARK No.	BAR TYPE AND SIZE (mm)	LENGTH OF EACH BAR (mm)	NO.OF BARS	TOTAL LENGTH (m)	SKETCH OF BA DIMENSIONS I (mm)		NOTES
ROOF BEAM 1	2	01	Y12	12000	4	48	11750		
ROOF BEAM 1	2	02	Y12	5450	4	21.8	5200	1250	
ROOF BEAM 1	2	03	Y12	5450	4	21.8	5200		
ROOF BEAM 1	2	04	Y12	12000	4	48	11750	1250	
ROOF BEAM 1	2	05	Y8	960	162	155.52	50 50 50 180	-	
ROOF BEAM 2	2	01	Y12	8750	8	70	8250	1250	
ROOF BEAM 2	2	02	Y8	960	80	76.8	50 50 00 180	-	
ROOF BEAM 3	1	01	Y12	8750	4	35	8250	1520	
ROOF BEAM 3	1	02	Y8	800	40	32	50 50 00 1100	-	
COLUMN FOOTING	2	01	Y12	1300	12	15.6	+100+	500	
COLUMN FOOTING	2	02	Y12	1300	12	15.6	900	1002	
COLUMN STARTER	2	03	Y8	820	10	8.2	50 50 1180	-	
COLUMN STARTER	2	04	Y12	1900	8	15.2	1600	3000	
COLUMN	2	01	Y12	2950	8	23.6	<del>2770</del>	180	
COLUMN	2	02	Y8	820	30	24.6	50 50 1180	-	





### 2CLASSROOMS DISTRIBUTION BOARD (DB-7) W 544 3 x 1.5 PVC/Cu 8 Nos. LIGHTS & 6Nos FAN (7-L1) 544 3 x 1.5 PVC/Cu 8 Nos. LIGHTS & 6Nos FAN (7-L2) 190 3 x 1.5 PVC/Cu 5 Nos. LIGHTS (2-L3) 3 x 2.5 PVC/Cu 2 Nos. 13A S/SOCKETS, 2-P1 300 1000 **SPARE** 63A/300mA SPN RCD 1000 **SPARE** 3.6Kw TOTAL CONNECTED LOAD IN KW 6 WAY SPN DISTRIBUTION BOARD WITH MCBs AND INTEGRAL 63A/300mA SPN RCD INCOMER AS ABB or Approved Equal, FOR FLUSH MOUNTING 3Cx16mm PVC/SWA/PVC/Cu 1 x 10 – PVC / C e.c.c FROM TANESCO LV POLE MINISTRY OF EDUCATION, SCIENCE AND TECHNOLOGY IN DRAWING TITLE: DRAWN BY EEC PROVISION OF PHYSICAL FACILITIES IN PRE COLLABORATION WITH TWO CLASSROOM BLOCK CHECKED BY EEC PRESIDENTS OFFICE REGIONAL ADMINSTRATIVE AND LOCAL PRIMARY SCHOOLS SCALE: NTS SCHEMATIC LAYOUT GORVENMENT DEC 2022 DRAWING NO: PRE/EL/CR/07

### **KEY TO SYMBOLS**

SYMBOL	DESCRIPTION	MOUNTING HEIGHT
	Distribution Board with integral RCD	2000 mm AFFL
Н	Bulkhead light Fitting	Wall Mounted
	4FT Single Electronic Start Fluorecent Light	On Ceilling
	Ceilling Fan	On Ceilling
	Fan Regulator	1500 mm AFFL
•	1 gang 1way Switch	1500 mm AFFL
4	1 gang 2way Switch	1500 mm AFFL
42	2 gang 2way Switch	1500 mm AFFL
3	3 gang 1way Switch	
2	2 gang 1way Switch	1500 mm AFFL
<b>A</b>	4 gang 1way Switch	1500 mm AFFL
11	Twin Switch Socket	450 mm AFFL
C	Ceilling light complete with energy saver 11w	on level

MINISTRY OF EDUCATION, SCIENCE AND TECHNOLOGY IN
COLLABORATION WITH
PRESIDENTS OFFICE REGIONAL ADMINSTRATIVE AND LOCAL
GORVENMENT

PROVISION OF PHYSICAL FACILITIES IN PRE PRIMARY SCHOOLS DRAWING TITLE: THREE CLASSROOM BLOCK LEGEND

DRAWING NO: P/EL/CR/07

DRAWN BY EEC
CHECKED BY EEC
SCALE: NTS
DEC 2022